

SPECIAL ANNOUNCEMENT REGARDING ARCHITECTURAL REVIEW BOARD MEETINGS

Section 610.015 of the Missouri Sunshine Law provides that members of the Architectural Review Board who are not physically in the City Council Chambers can participate and vote on all matters when an emergency exists and the nature of the emergency is stated in the minutes

The U.S. and the world is in a state of emergency due to the Coronavirus – COVID-19. Therefore, members of the Architectural Review Board have elected to participate in this meeting electronically for the public health and safety of each other and the general public.

Zoom webinar

When: July 6, 2021 07:00 PM Central Time (US and Canada)

Topic: Architectural Review Board

Please click the following link to join the webinar: https://zoom.us/j/93792854141

Or One tap mobile:

US: +13126266799,,93792854141# or +16468769923,,93792854141#

Or Telephone:

Dial (for higher quality, dial a number based on your current location): US: +1 312 626 6799 or +1 646 876 9923 or +1 301 715 8592 or +1 669 900 6833 or +1 253 215 8782 or +1 346 248 7799 or +1 408 638 0968

Webinar ID: 937 9285 4141

International numbers available: https://zoom.us/u/abZ68XXb7A



Architectural Review Board AGENDA July 06, 2021 at 7:00 p.m. Via Zoom (electronic meeting)

- I. Approval of Minutes June 21, 2021
- II. Sign Review Old Business

None

III. Sign Review - New Business

- a. 19-21S 902 S Kirkwood Rd I1
 Chris Smith, Dale Signs, applicant
 Wall Sign, Monument Sign & Driveway Signs for No Leash Required
- b. <u>20-21S 10463 Manchester Rd B4</u>
 Piros Signs, Inc., applicant
 Wall Signage and Menu Board for Chicken Out

IV. Residential Review - Old Business

a. Case 84-21R – 445 N Taylor Ave – R3

Mike Lewis, applicant

One-Story Addition

Continued on 6-21-21 for additional information and 3-D renderings.

b. Case 85-21R – 549 N Van Buren Ave – R4

Nathan Rauh of Naismith-Allen, Inc., applicant

Two-Story Addition

Continued on 6-21-21 for additional information and updated elevations.

c. <u>Case 89-21R – 1007 Krauswood Dr – R3</u>

Robert & Maureen Reed, applicants

Enclosing Existing Deck

Continued on 6-21-21 for material cut sheets and a more detailed drawing.

d. Case 92-21R – 411 W Adams Ave – R4

Michael Blaes, AIA, applicant

New Single-Family Home

Continued on 6-21-21 due to the applicant being unavailable to address the board.



Architectural Review Board AGENDA July 06, 2021 at 7:00 p.m. Via Zoom (electronic meeting)

V. Residential Review - New Business

- Case 52-21R 555 N. Clay Ave R3
 Jim Hotop, Coach House Garages, applicant Detached Garage
- b. Case 96-21R 473 Longfellow Ave R4
 C.J. Moss, Chesterfield Fence & Deck, applicant Covered Deck Addition
- Case 97-21R 612 S. Ballas Rd R3 MRM Manlin Development Group, applicant New Single-Family Residence
- d. <u>Case 98-21R 616 S. Ballas Rd –R3</u> MRM Manlin Development Group, applicant New Single-Family Residence
- e. Case 99-21R 315 Crest Ave –R4
 Kingbridge Homes LLC, applicant
 New Single-Family Residence
- f. Case 100-21R 918 Cleveland Ave R4
 Lakeside Renovation and Design, applicant
 1 ½ Story Rear Home Addition
- g. Case 101-21R 438 Greenleaf Dr R3 Jared Byers, applicant Screened Porch and Rear Home Addition
- VI. Commercial Review Old Business
 None
- VII. Commercial Review New Business
 None
- VIII. Election of Officers



Architectural Review Board AGENDA July 06, 2021 at 7:00 p.m. Via Zoom (electronic meeting)

Kirkwood Architectural Review Board Members: Chairman Mark Campbell; Vice Chairman Michael Chiodini; Don Anderson, Curt Rafferty, Dick Gordon, Adam Edelbrock and Pat Jones; Council Liaison Kara Wurtz

Contact Information: For full Architectural Review Board contact information, please call Planning and Development Services at 314-822-5823. To contact the Building Commissioner, call Jack Schenck at 314-822-5814.

Accommodation: The City of Kirkwood is interested in effective communication for all persons. Persons requiring an accommodation to attend and participate in the meeting should contact the City Clerk at 314-822-5802 at least 48 hours before the meeting. With advance notice of seven calendar days, the City of Kirkwood will provide interpreter services at public meetings for languages other than English and for the hearing impaired.

C: Bill Bensing, Director of Public Services
Laurie Asche, City Clerk
Kim Sansegraw, Deputy City Clerk
Tim Griffin, Mayor
Kara Wurtz, Council Liaison
Donna Poe, SBD
Freddy Doss, Public Information Officer
Jonathan Raiche, Director of Planning and Development Services
Amy Lowry, Planner II
Andi Yancey, Planner I



Architectural Review Board

JUN 1 1 2021

Sign Review Application139 S. Kirkwood Rd. Kirkwood, MO 63122 (314) 822-5816 Fax (314) 822-5898 CITY OF KIRKWOOD


WHERE COMMUNITY AND SPIRIT MEET*

	PUGLIC WORKS DEPARTMENT
Property Address: 903 S, Kirkwood Rd.	11 Case # 19-21 S Permit# 22-109
Person Requesting Review	Property Information
Application Date: 6-10-21 Name: Chris Smith Address: 13652 Manchester Rd. City/State/Zip: Stikow's, Mo. 63131	Owner Name: Robert Vatteratt Properties Inc. Address: 910 S. Kickwood Rd. Svite 140 City/State/Zip: St. Lovis, Me. 63122 Phone: 314-280-5354
Phone: 314-966-2626 E-mail: chris@dalesigns.com Cell Phone:	Is the Property a Local Historic or a Landmark? YES / NO
Contractor's License No. 21-00001114	Existing/New Business (circle one)
	Zoning District <u>I1</u>
ARB meetings are held on the 1 st & 3 rd I	REVIEW SHALL BE - 11"x 17" FORMAT** Mondays (excluding holidays) every month.
"Submittals must be turned in by	y 2: 00 p.m. on the deadline date*
 ARB Approves Permit Applications for Signs in account information is required for review: 	ordance with the City Code of Ordinances. The following
☑Ten (10) sets of a site plan showing the proposed lo	ocation of the signs(s)
Ten (10) sets of detailed sign drawings (showing sig	gn dimensions, material, color, style, lighting, etc.)
Ten (10) sets of photographs of building face and a	djacent buildings (within 100 ft.) where sign is to be located.
Ten (10) color renderings of sign	
Completed sign permit application and sign review	ew information worksheet
Filing Fee \$100.00 For sign review, \$240 to consider review only; a separate sign permit shall be obtain	er variance from sign code due to hardship. Fees are for ARB ned from the Building Commissioner's Office.
to install the approved sign.	ned from the Building Commissioner's Office within 90 days
located on property which I have the legal right to constru statements are true and correct and agree to fully comply	y with the ordinances of Kirkwood. I hereby certify that the we been authorized by the owner(s) to make this application
Chris South Chris So	nith 6-10-21
Applicant's Signature Applicant's Pr	rinted Name Date
CITY USE	eve new for future V pplication Date: 6-11-21
Received By: Salvara Pelby as	pplication Date: 6-11-21
ARB Agenda Date 7 6 2021. Zoning Adm	ninistrator Approval

Sign Review Information Worksheet

*PLEASE COMPLETE ENTIRELY - Incomplete submissions will be returned for completion

	Type of Sign Requ	iested:		
☐ Awning ☐ Ground	Exempt Signs (re	eviewed):		
☐ Marquee ☐ Projecting	Subdivision or Apartment Complex			
	☐Commercial Signs in residential areas ☐Other			
☐ Roof ▼ Wall	other			
☐ Window	Variance Request:			
	☐Variance Re	equest:		
	Size of Proposed S	Sign(s)		
13'-8	e" X 4/2%"	= 57.5	sg. ft.	
135.	15" X 45,125"	= 6103.16" = INH = H	38" sq. ft.	
2	2' X 2'	= 4'	sq. ft.	
6	Y 2'	= 4'	sq. ft.	
	Total Size		sq. ft.	
	Existing Signs to F	Pemain		
	X	=	sq. ft.	
	X	12	sq. ft.	
	X	=	sq. ft.	
	X	=	sq. ft.	
Tot	al Existing Size		sq. ft.	
Total existing gross sign area			sq. ft.	
Floor area of building		= 9800	sq. ft.	
Floor area of tenant (if different)		=	sq. ft.	
Lot area		= 1,13 Acres	sq. ft.	
Dimensions of wall or window - sig	gn to be applied to	E I I I I I I I I I I I I I I I I I I I	sq. ft.	
Gross Allo	wable Sign Area for	Single Tenant Site:		
3.5% of the floor area		= 343 \	sq. ft.	
.9% of the total lot area		= 4430 V	sq. ft.	
Whichever percentage is larger, not allowed maximum sign area of 1,500		feet. Lots 10 acres or greater	shall be	
Gross Allowable Si	gn Area for Single To	enant in Multi-Tenant Site:		
GIOSS Allowable Si				

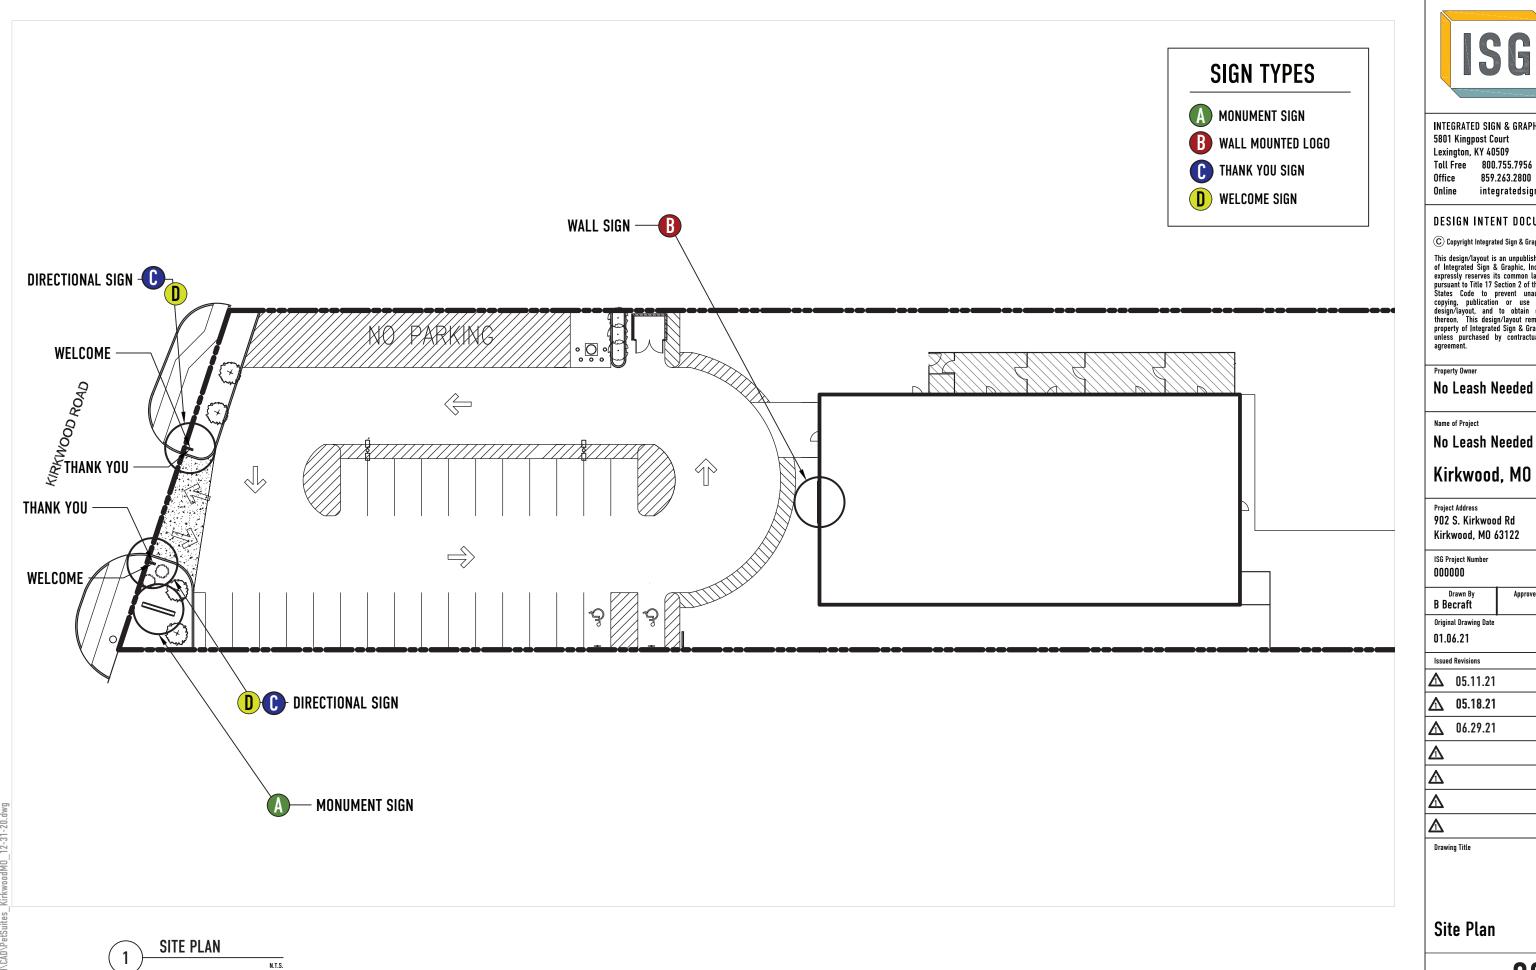

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No Leash Needed

Kirkwood, MO

902 S. Kirkwood Rd

Approved By

Standard Colors & Materials

Corporate Color Standards



No Leash Grey PMS 427c CMYK: 16.02/12.89/12.89/0 RGB: 212/211/210

No Leash Black PMS Black 6c CMYK: 74.97/67.92/67.05/90.15 RGB: 0/0/0



No Leash Red PMS 1788c CMYK: 0/99.33/100/0 RGB: 237/32/36

Paint Colors



P-1 Paint to Match (PMS 447c) Matthews Paint



P-2 Grey Shank (MP 13914) Matthews Paint



Matthews Paint 542



P-4 Dark Grey to match Sherwin-Williams 6992 Ink Well

Vinyl Colors



V-1 To Match PMS 427c (3M Scotchcal)



V-2 3M Opaque Black Vinyl (7725-12)



V-3 3M Poppy Red Translucent 3630-143



V-4 80/20 Black Perforated Vinyl

Trim Cap Colors



T-1 Gemini - To Match PMS Black 6c



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Property Owner

No Leash Needed

Name of Project

No Leash Needed Kirkwood, MO

Project Address 902 S. Kirkwood Rd Kirkwood, MO 63122

Approved By

ISG Project Number 000000

Drawn By B Becraft Original Drawing Date

01.06.21

Issued Revisions

⚠ 05.11.21 ⚠ 05.18.21

 Δ 06.29.21


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Drawing Title

Materials and Colors



V-1 To Match PMS 427c (3M Scotchcal)

Translucent Vinyl Colors

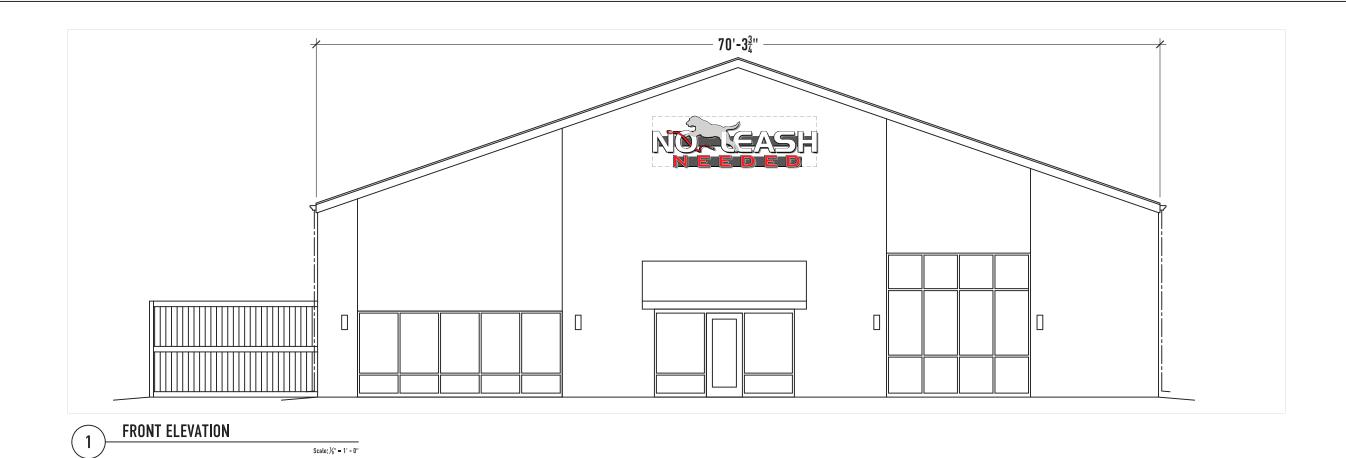V-2 3M Opaque Black Vinyl (7725-12)

V-3 3M Poppy Red Translucent 3630-143

V-4 80/20 Black Perforated Vinyl

P3 - 3/16" WHITE ACRYLIC 7328 13'-8" 4'-2¹'' 1'-8⁵/₈" 11³" 10'-6½" - RED TRANSLUCENT VINYL V-3 - BLACK TRIM CAP AND RETURNS 4" DEEP FACE LIT CHANNEL LETTERS

Trim Cap Colors

T-1 Gemini - To Match PMS Black 6c



57.47 Sq. Ft.



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Name of Project

No Leash Needed

Kirkwood, MO

Project Address

902 S. Kirkwood Rd Kirkwood, MO 63122

ISG Project Number

000000

Drawn By B Becraft

Approved By

Original Drawing Date 05.11.21

Issued Revisions

⚠ 05.11.21

 $|\Delta|$ 05.18.21

Λ 06.29.21

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Drawing Title

Wall Mounted Logo **Building Elevations**





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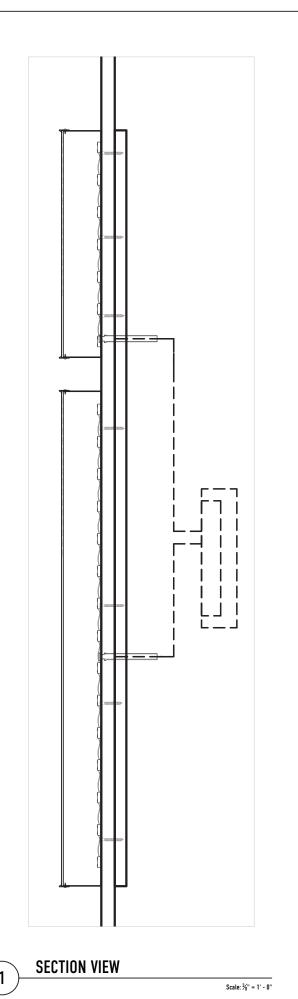
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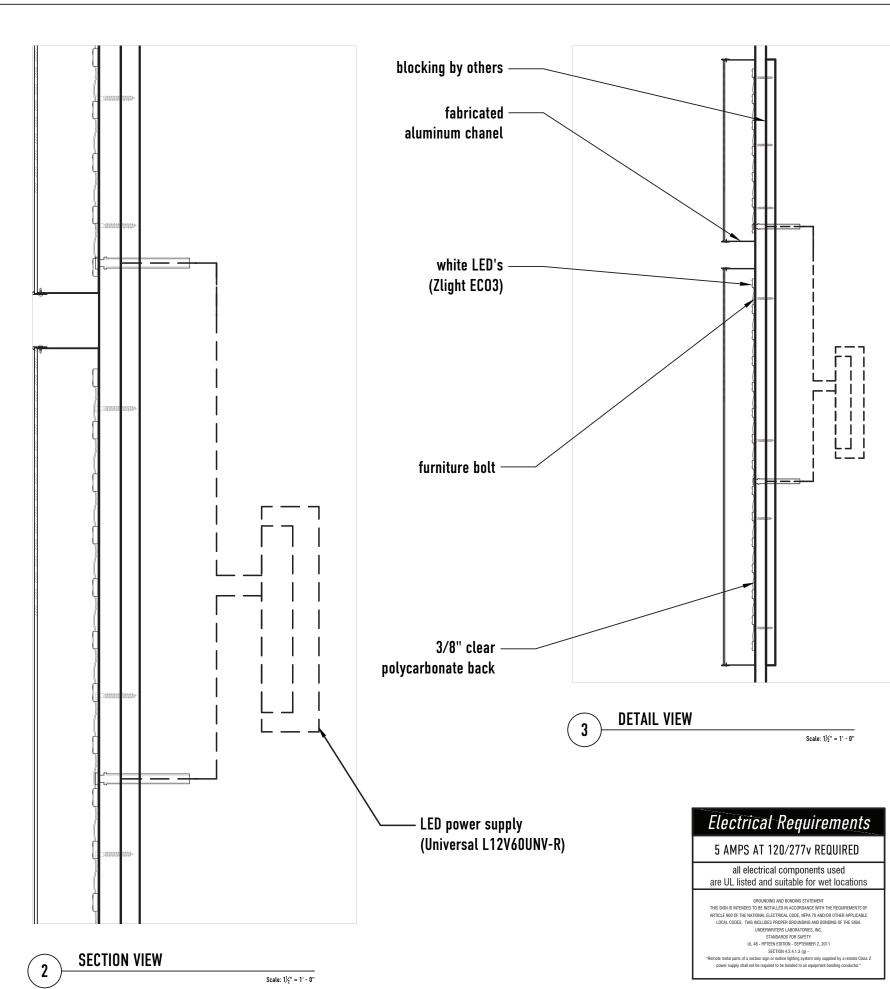
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Drawing Title

Materials and Colors

005





ISG

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Kirkwood, MO

Project Address

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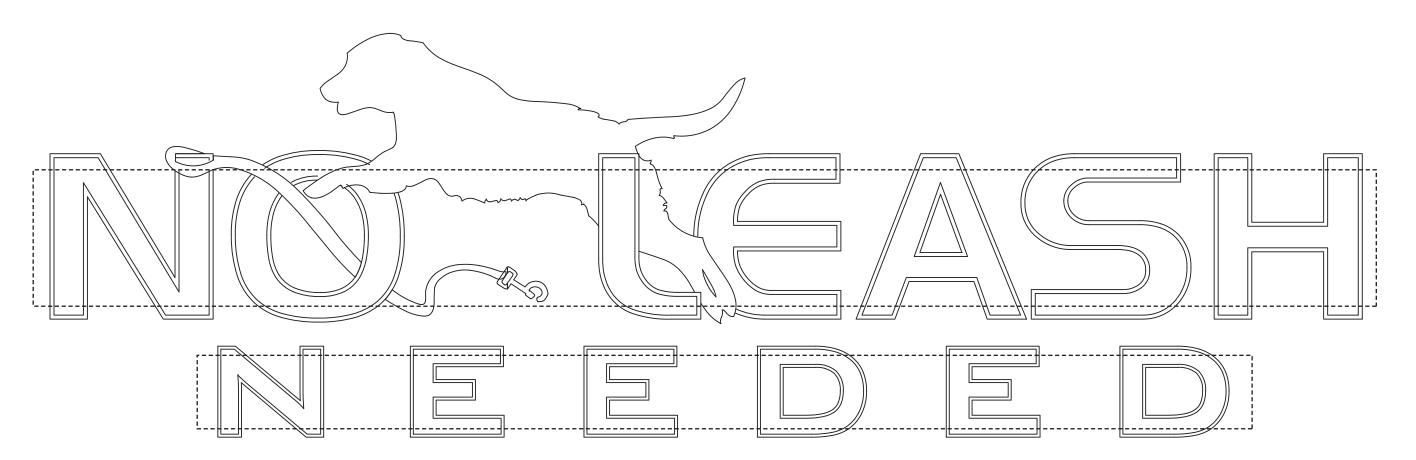
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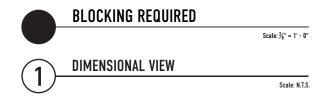
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Drawing Title

Silhouette Section Details

006







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Name of Project

No Leash Needed Kirkwood, MO

Project Address

902 S. Kirkwood Rd Kirkwood, MO 63122

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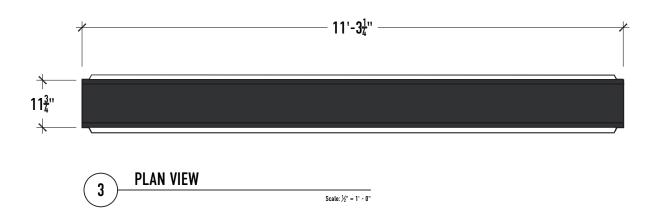
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Drawing Title

Wall Sign Blocking Requirements



· 11'-3¹"

Scale: ½" = 1' - 0"

FRONT VIEW



Colors & Materials

Paint Colors



P-1 Paint to Match (PMS 447c) Matthews Paint



P-2 Grey Shank (MP 13914) Matthews Paint

Printed Colors




To Match PMS 427c



To Match PMS Black 6c



To Match PMS 1788c

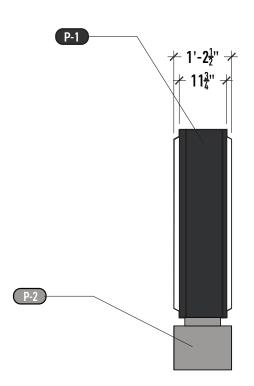

SIDE VIEW

Scale: ½" = 1' - 0"

56.36 Sq.Ft.

3'-11¹/₈"

 $10\frac{7}{8}$ "

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No Leash Needed

Name of Project

No Leash Needed Kirkwood, MO

Project Address 902 S. Kirkwood Rd Kirkwood, MO 63122

ISG Project Number 000000

Drawn By B Becraft Original Drawing Date Approved By

01.06.21

Issued Revisions

⚠ 05.11.21 **⚠** 05.18.21

Λ 06.29.21

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Drawing Title

Materials and Colors

008



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Name of Project

No Leash Needed

Kirkwood, MO

Project Address

902 S. Kirkwood Rd Kirkwood, MO 63122

Approved By

ISG Project Number

000000 Drawn By

B Becraft Original Drawing Date

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⚠ 05.18.21

Δ 06.29.21

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Electrical Requirements

5 AMPS AT 120/277v REQUIRED all electrical components used are UL listed and suitable for wet locations

GROUNDING AND BONDING STATEMENT
THIS SIGN IS INTENDED TO BE INSTALLED IN ACCORDANCE WITH THE REQUIREMENTS OF
ARTICLE 000 OF THE NATIONAL LECETRICAL CODE, INFO 70 AND/ORD OTHER APPLICABLE
LOCAL CODES. THIS INCLULES PROFER GROUNDING AND BONDING OF THE SIGN.
UNDERWRITERS LABORATORIES, INC.
STATANDANDS FOR SAFETY
U. 48 - FIFTEN EDITION - SEPTEMBER 2, 2011
SECTION 42-4.1.3 (g) **Remote metal parts of a section sign or cutter lighting system only supplied by a remote Class 2
power supply shall not be required to be bonded to an equipment bonding conductor.*

Drawing Title

Monument Section Details

Pet Suites Silhouette Pet Suites Silhouette Pet Suites Silhouette Pet Suites Silhouette Pet Suites Silhouette

Colors & Materials

Paint Colors


P-1 Paint to Match (PMS 447c) Matthews Paint



Translucent Vinyl Colors


V-2 3M Opaque Black Vinyl (7725-12)


V-3 3M Poppy Red Translucent 3630-143

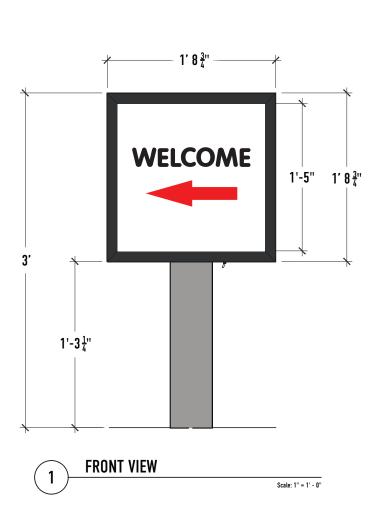

- 1' 8 3" -

PLAN VIEW

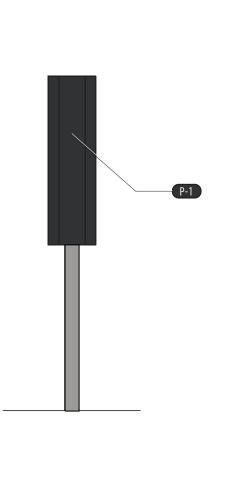

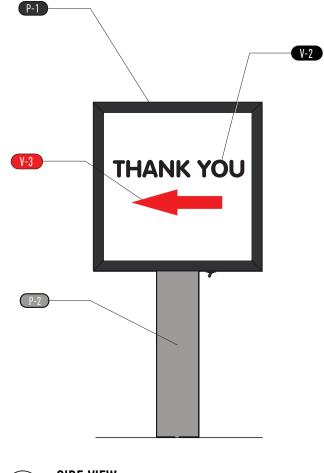

SIDE VIEW

Scale: 1" = 1' - 0"

3 Sq.Ft.



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Property Owner

No Leash Needed

Name of Project

No Leash Needed

Kirkwood, MO

Project Address 902 S. Kirkwood Rd Kirkwood, MO 63122

ISG Project Number

Drawn By Approved By B Becraft
Original Drawing Date

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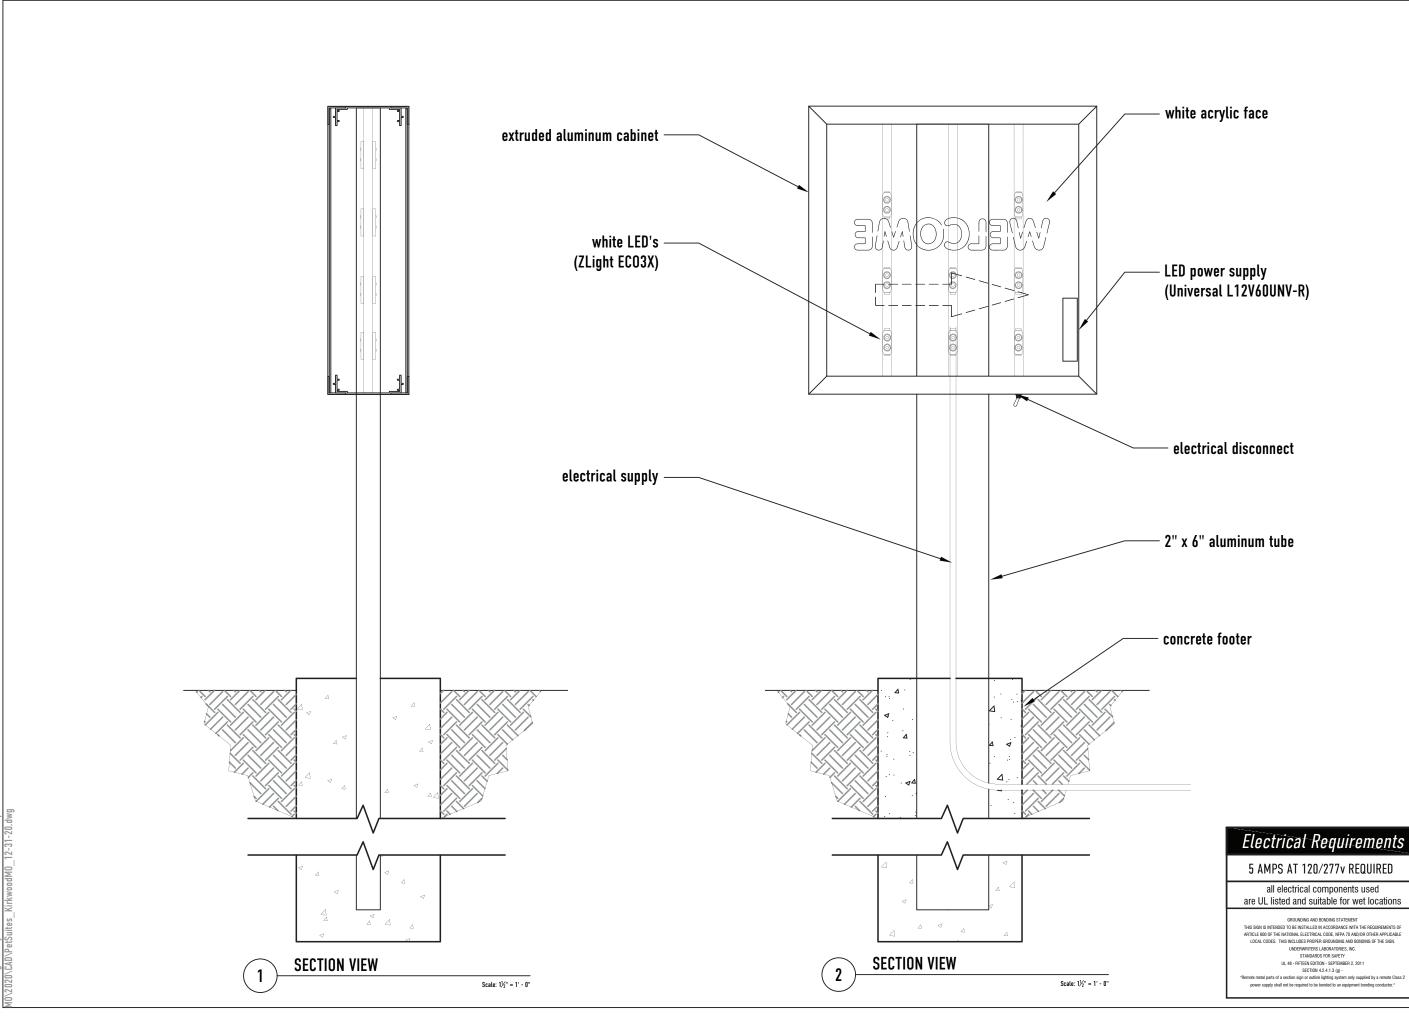
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Drawing Title

Directional Sign Dimensions

010





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Property Owner

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Name of Project

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Kirkwood, MO

Project Address

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ISG Project Number

000000 Drawn By

B Becraft

Approved By

Original Drawing Date 01.06.21

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Δ 06.29.21

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Drawing Title

Directional Sign Section Details



L12V60UNV-R

12 Volt 60 Watt Class 2 LED Driver

- ➤ Universal input voltage 120 277 Vac
- ➤ Damp and Dry Location Rated
- ➤ Class 2 Output

Performance	
Input Voltage	120 ~ 277 Vac
Input Current Max	1.2A @ 120Vac
input current iviax	0.7 @ 277Vac
Input Power Max	72W
Input Frequency	50 - 60 (Hz)
Efficiency	> 85 % @ 120Vac
Efficiency	> 87 % @ 277Vac
Output Voltage	12V
Output Current	5.0A
Output Power	60W
Line Regulation	±5 %
Load Regulation	±5 %
Output Voltage Ripple	< 1000mVp-p
Output Current Ripple	< 500mAp-p
Inrush Current	120V: 40A / 160uS
Peak / >50% Duration	277V: 105A / 160uS

- * Refer to charts for additional information
- Harmonic Emissions comply with ANSI C82.77
- Inrush current complies with NEMA 410

Wiring Diagram:

Line	Black		Red	-
Neutral	White	LED Driver	Positive Black	LED Chains
V-2 50 - 20	20.000		Negative	

Physical	
Length	5.50 in (140 mm)
Width	1.70 in (43.2 mm)
Height	1.18 in (30.0 mm)
Mounting Length	5.24 in (133.0 mm)
Weight (lbs)	0.8
Lead Lengths	
Blk, Wht	12.5 in (317.5mm)
Red(+), Black(-)	12.5 in (317.5mm)

Environmental	
EMI and RFI	Meets FCC part 15 (Class A)
Livii aliu iti i	Non-Consumer Limits
Operating	-40°C to 55°C
Temperature	(-40°F to 131°F)
Storago Tomporaturo	-40°C to 85°C
Storage Temperature	(-40°F to 185°F)
tc	85°C max for warranty
ic .	90°C max for UL
Protection Rating	UL Dry & Damp
Transient Protection	IEEE C62.41 2.5kV

Protection

Over Voltage, Under Voltage, Short Circuit, Over Temp Safety:

UL 8750

UL Class P





Ordering Information

Order Number	Description	Qty/Carton
L12V60UNV-R000I	12V 5.0A	10



Application and operation performance specification information subject to change without no tillcation.

Page 1 of 3

www.unvlt.com

June 27, 2018







LED Module - ECO3X

WWW.NEISLS.COM

Applications:

ZLight ECO3X white LED modules are designed for channel letters and sign cabinets with a 3 to 10 inch can depth. With revolutionary high power LEDs, you can achieve tremendously money-saving advantages over traditional neon and fluorescent tubes. The optimum lens covering LEDs create an impressively even light coverage of the letter and sign face.

Features

LEDs:

Super Bright LEDs L70 Rating 50,000 hours

Power Input:

Input Voltage: 12 VDC

Optical Structure:

Designed for Maximum Brightness Output

System:

1.5 modules per foot

100 modules per bag, 10 bags per carton

Peel-N-Stick and mechanical fastening, Waterproof, IP 66

Voltage Drop Prevention (VDP) Technology

UL and cUL Recognized/SAM Listed


Warranty: 10 Years



Detail Specifications

Model	Voltage	Power	# of	Module / Color	Color	Brightne	SS	View	Qty per
Model	(VDC)	(W)	LEDs	FT	Color	lm/module	lm/ft	Angle	60W P.S
Z-EC03X-W	12	1.2	2	1.5	White (7,100K)	144	216	170°	50

Distance from Face	2"-3"	3" - 4"	4" - 5"	5" - 6"	6"-10"
Spacing Row to Row	5" (3 Mods/FT)	7"(2 Mods/FT)	8"	10"	12"

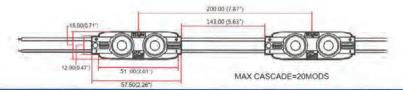

Zlight Technology LLC 325 Funston St. Elmwood, LA 70123 www.zlighttech.com

Phone: 504-322-4516 Fax: 504-836-0008

INTEGRATED SIGN & GRAPHIC, INC. 5801 Kingpost Court

Lexington, KY 40509 Toll Free 800.755.7956 859.263.2800 Office

Online integratedsign.com

DESIGN INTENT DOCUMENT

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Property Owner

No Leash Needed

Name of Project

No Leash Needed

Kirkwood, MO

Project Address

902 S. Kirkwood Rd Kirkwood, MO 63122

ISG Project Number 000000

Drawn By Approved By B Becraft Original Drawing Date

01.06.21 **Issued Revisions**

⚠ 05.11.21

 Λ 05.18.21

Λ 06.29.21

Δ Δ

Λ

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Drawing Title

Electrical Components







ARCHITECTURAL REVIEW BOARD

SIGN REVIEW APPLICATION


139 S. Kirkwood Rd., Kirkwood, MO 63122 | (314) 822-5823


ARB meetings are held on the 1st & 3rd Mondays (excluding holidays) every month. Applications, required plans, and supporting documents must be turned in on the deadline date by 2:00 pm. Incomplete submittals will not be accepted. Please see checklist for requirements.

A TOTAL CONTRACTOR OF A STATE OF A	Act Company Character	RECORD AND AND ADDRESS OF THE PARTY OF THE P
PROJECT ADDRESS: 10463 MANCHESTER PO		Zone: <u>B-4/</u>
Is this Property a Local Historic or Landmark?	□ Yes	D≮No
Is this a New Business?	⊠ Yes	□ No
Has an Occupancy Permit been applied for?	⊠Yes	□ No
Property Owner Information:		
Name MANGHESTER 104610 LLC		
E-mail STEVE O NOLANTY. COM	Phone	
Is the Owner's written approval for the sign installation incl	uded?	□ No
Applicant Information: ☐ Contractor ☐ Property Owner	☐ Tenant	☐ Other
Name Pirus Signs, Tuc	KWD LIC. NO.	22.25
Address 1818 DLD STATE TROAD IN	City/State/Zip	BARNHARE, 120 630
E-mail TPHILLIPS @ PIROSSIGNS, COM	Phone <u>636-4</u>	
Sign Installer Information:		
Business Name Piros Signs, INC	KWD LIC. NO.	22-255
E-mail TPHILLIPSO PIRUSSIBAS, COM	Phone 636.4	
Fees are for ARB review only; a separate fee is require		
□ \$100 Filing Fee □ \$240 Sign Review Fee to consider	variance from Sig	n Code due to hardship.
\square I have read the Architectural Review and sign regulations of the City	of Kirkwood.	
$\hfill \square$ I hereby certify that the Owner(s) of Record authorizes the proposed to make this application as their agent.	work and I have be	en authorized by the Owner(s)
☐ I hereby certify that the project is located on property I have the lega	I right to construct	the proposed project at.
☐ I hereby certify that all the information provided is true and accurate to fully comply with the Ordinances of the City of Kirkwood.	to the best of my kr	nowledge and belief and agree
☐ I understand that the applicant or their representative sha	II attend all mee	tings.
Applicant's Signature:	TO A STANS	With the second
Applicant's Printed Name: 108 Phillips	Date:	US-21-2021
City Use Only Date	e Stamp	N
Case #: 20 - 21S		
Permit #: 22 - 1259 ARB Agenda Date: 07/06/202	2 3 2021	Zoning Approval:
Received By:		Page 1of 2

Sign Review Information Worksheet
Please complete entirely. Incomplete submissions will be returned for completion.

Type of Sign:	☐ Awning ☐ Ground		ojecting 🖾 Wall □ Window
Exempt Signs (reviewed):	☐ Subdivision or Apart	ment Complex	mmercial Sign in residential area
Type of Variance Requested:	N/A		
Gross Allowable Sign Area for Lots 10 acres or greater shall be			arger, not to exceed 500 square fee
3.5% x Floor Area:		.9% x Total Lot Area:	Sq.Ft.
Gross Allowable Sign Area fo 500 square feet. Multiple tenan	or Single Tenant in Multi- t buildings and/or premises	Tenant Site: Maximum of may have only one grou	gross allowable for this type of sign and sign.
3.5% x Occupied Floor Area:	103.14 Sq.Ft.		
Total Existing Gross Sign Area	ϕ	Sign Wall / Window Dir	mensions: 27.33' + 37.00'
Building Floor Area:		Tenant F	loor Area: AGUOSF
Lot Area:			
Proposed Sign(s):			
Location		Size h x Width	Total Square Feet
Front	54"	× _115"	43.13 +
Rear	54"	x 115	43.13 +
□ Side		x	
☐ Other:		x	
☐ Other:		x	
		TOTAL SIZE:	86.26 +
Existing Sign(s) to remain:	NIA		
Location		Size h x Width	Total Square Feet
☐ Front		х	
□ Rear		х	
□ Side		х	
☐ Other:		x	
☐ Other:		x	
7 18.19.1	тот	AL EXISTING SIZE:	

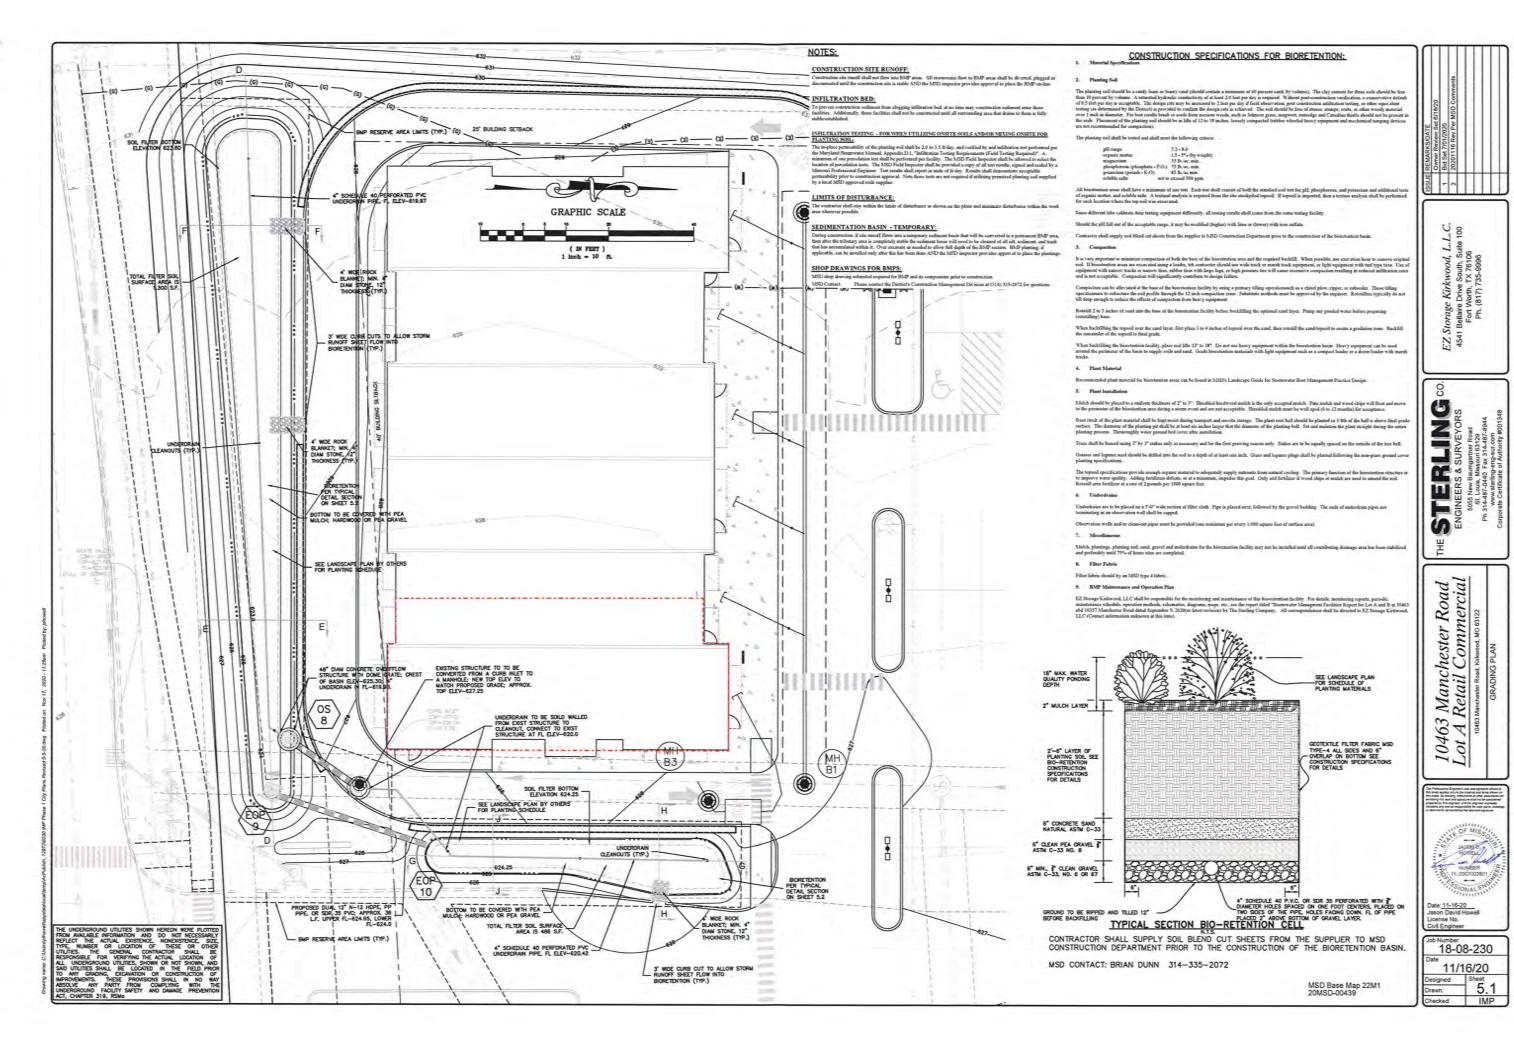


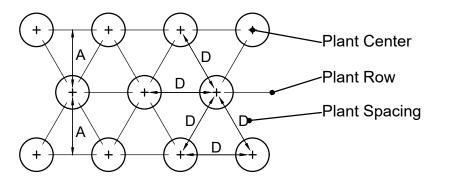

Bioretention Plant Spacing

Plant Spacing Table

Spacing 'D'	Row 'A'	Number of Plants / Square Feet
30"	26"	.16
24"	20.8"	.25
18"	15.6"	.45
15"	13"	.64
12"	10.4"	1.00
10"	8.66"	1.44
8"	6.93"	2.25

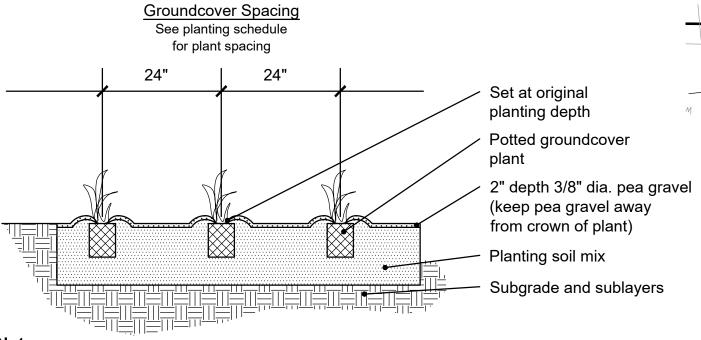

- 1. Remove spent flowers prior to planting.
- 2. Loosen root mass at bottom of rootball.
- 3. Top of rootball stripped of 1/4" surface growing media and covered with 1/4" landscape bed mix plus surface mulch.

Bioretention Plant Spacing Section

Note: Plant quantities to be determined by multiplying area (sq.ft.) by number of plants/sq.ft. for required spacing. Table and diagram taken from "Landscape Guide for Stormwater Best Management Practice Design" by MSD with a revised date of May 2, 2012.

Table 1: Planting, Water, and Mulch Requirements


Water Availability	Required Planting Period	Minimum Container Size	Water Requirement First 3 Weeks	Water Requirement After 3 Weeks*	Maximum Mulch Depth****
No ability to water after initial planting	Late FebApril only	2.25"x3.75" or larger (plug)	Water each plug immediately after planting		1.5" for plugs
Manual watering with standard sprinkler	Late FebEarly June SeptOctober	4.5"x5" (quart) or larger in summer and fall	1" (60 min) every 4 days	1" (60 min) every 7 days until plants established***	1.5" for plugs 2.5" for quarts
Automatic irrigation (set to water more frequently than normal during first two months after planting)	Late FebEarly Oct.	2.25"x3.75" (plug) or larger in spring 4.5"x5" (quart) or larger in summer and fall	1" (60 min) every 4 days in spring and fall 1" (60 min) every 3 days in summer)	1" (60 min) every 7 days until plants established***	1.5" for plugs 2.5" for quarts

*This water amount includes natural rainfall. If you get a $\frac{1}{2}$ inch of natural rain, then you will need to add a $\frac{1}{2}$ inch of water to meet the 1 inch requirement. **Requires transport of water to the planting site in large containers and pouring enough water onto each plant (after planting) to moisten the entire planting pit.


***Plants are established when roots have grown out of the container soil and into the native soil by 3-5 inches. This normally takes 3-4 months for most

perennials and grasses and up to 6-7 months for trees and shrubs. ****Shredded leaf compost is recommended for use with perennials and grasses. Mulch is recommended for tree and shrub plantings at a depth of 3 inches.

			PLANTING SCHEDULE		
SYMBOL	QUANTITY	BOTANICAL NAME	COMMON NAME	SIZE	REMARKS
CAN	OPY-SHA	ADE TREES		•	
F	8	Taxodium distichum 'Mickelson'	Shawnee Brave Bald Cypress	2" cal.	B&B
BIOF	RETENTIO	ON PLANTS		•	
hh	3	Aronia melanocarpa	Black Chokeberry	24"	Container
jj	3	Ribes aureum	Golden Currant	24"	Container
kk	3	Callicarpa americana	Beautyberry	24"	Container
mm	45	Sporobolus heterolepis	Prairie Dropseed	Type 38 DCP	24" o.c.
nn	51	Carex muskingumensis	Palm Sedge	Type 38 DCP	24" o.c.
rr	32	Bouteloua curtipendula	Sideoats grama	Type 38 DCP	24" o.c.
SS	16	Carex praegracilis	Tollway Sedge	Type 38 DCP	24" o.c.
tt	62	Chasmanthium latifolium	River Oats	Type 38 DCP	24" o.c.
uu	38	Asclepias tuberosa	Butterfly Weed	Type 38 DCP	24" o.c.
VV	40	Rudbeckia fulgida	Orange Coneflower	Type 38 DCP	24" o.c.
ww	19	Lobelia siphilitica	Blue Cardinal Flower	Type 38 DCP	24" o.c.
XX	49	Baptisia sphaerocarpa	Yellow Wild Indigo	Type 38 DCP	24" o.c.

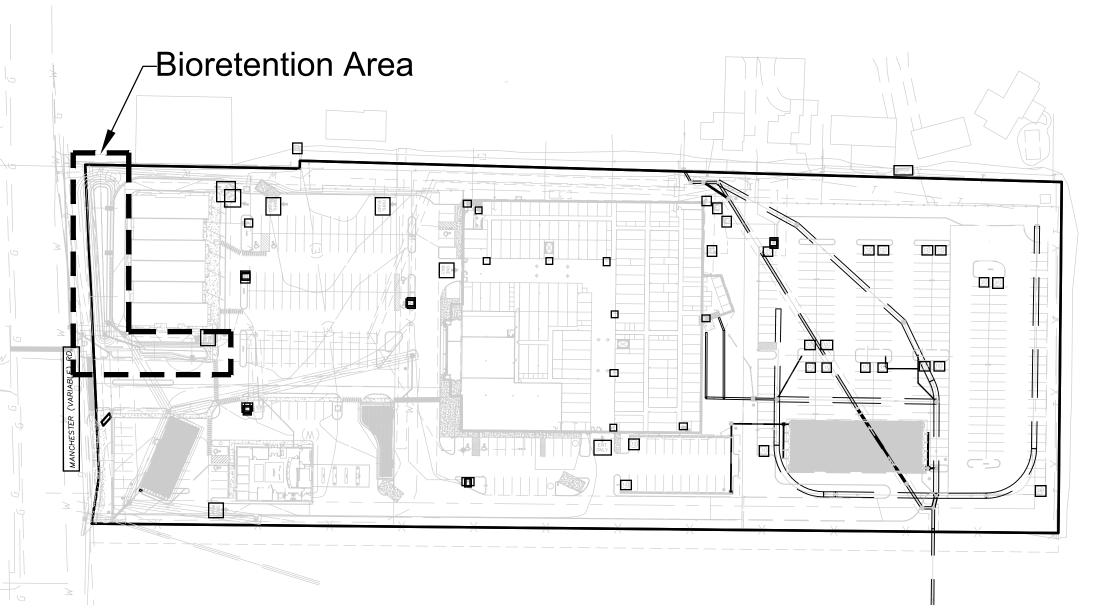



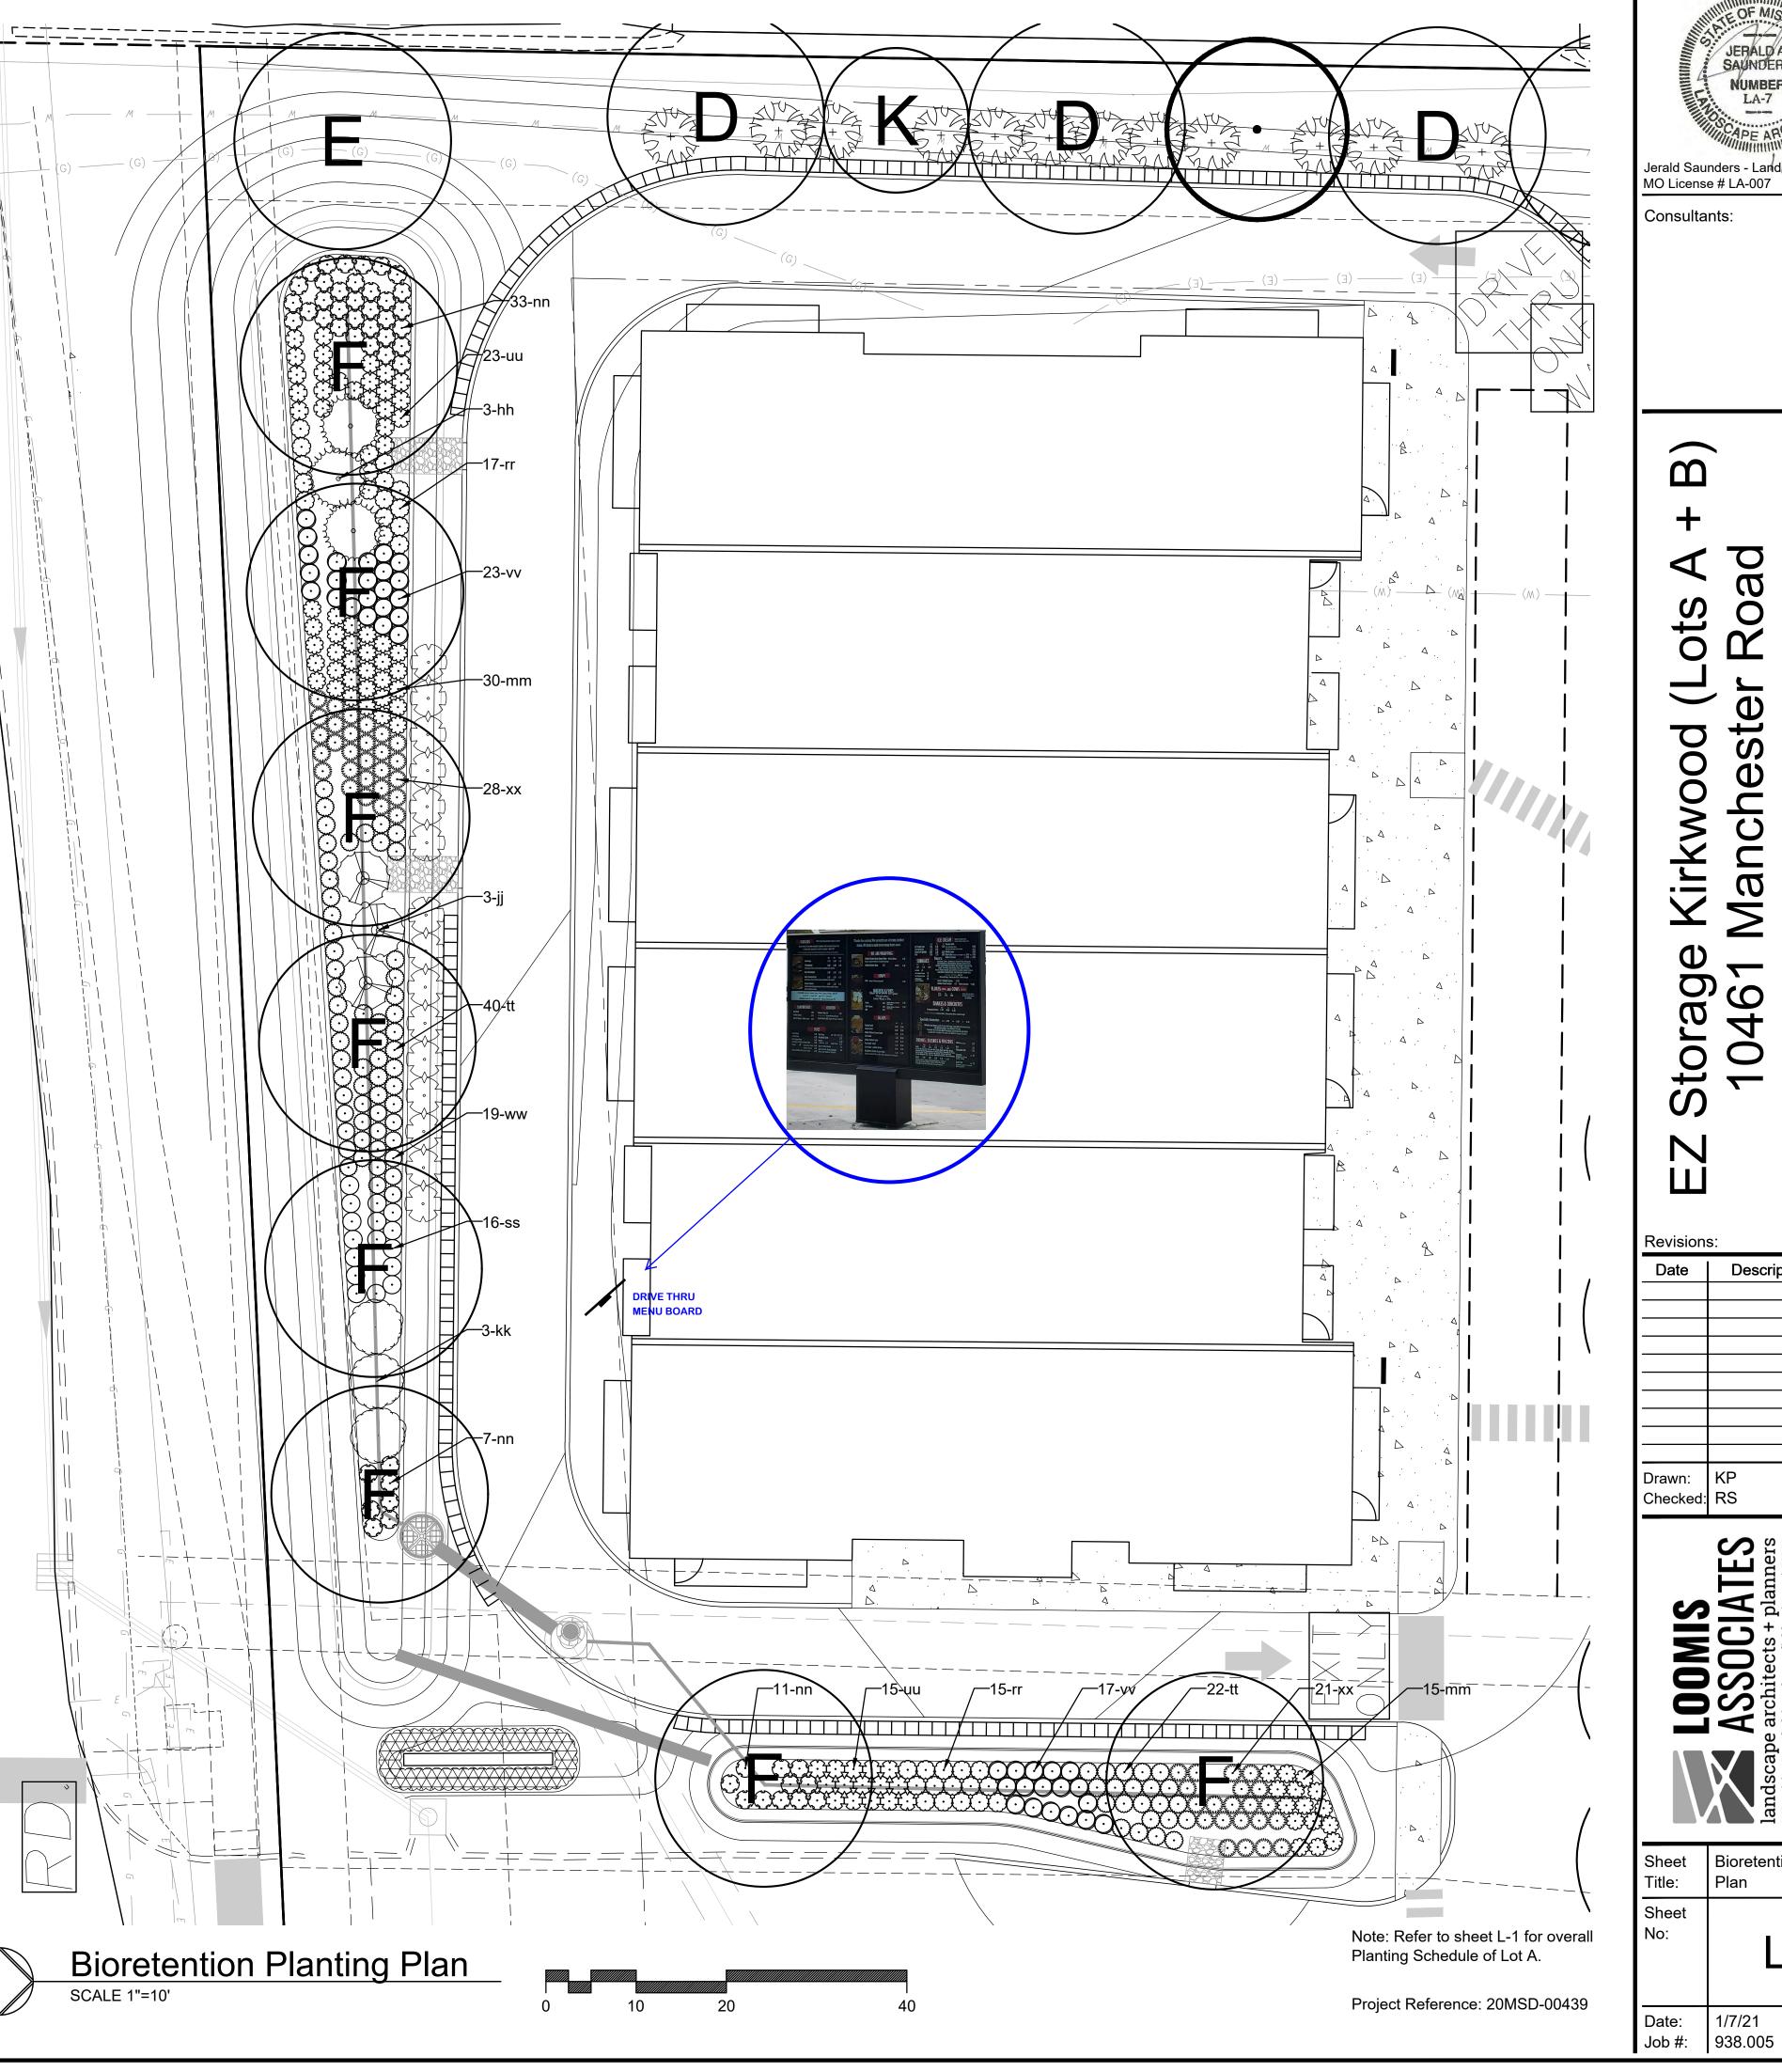



Road Manche orage 0461

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Revision	s:	
Date	Description	No.
		┼
		+-
		+
		<u> </u>
		+-
Drawn:	KP	
Checked:		
	ASSOCIATES landscape architects + planners 750 spirit 40 park drive, chesterfield, missouri 63005 t. 636-519-8668 www.loomis-associates.com	Loomis Associates Inc. Missouri State Certificate of Authority #: LAC #000019
Sheet Title:	Bioretention Pla Plan	
Sheet		

L-2



1818 HWY. M BARNHART, MO 63012 PH: 636-464-0200 FAX: 636-464-9990 WWW.PIROSSIGNS.COM GRAPHICS@PIROSSIGNS.COM

CUSTOMER Chicken Out

JOB LOCATION Kirkwood, MO

CONTACT

SALES PERSON

David Brand, Jr.

DATE

5-25-21 DRAWN BY

Eric Irvin

SAVED AS

211145 Chicken Out Kirkwood Wall Signs

RENDERING # 211145-03

REVISION(S) -02: Removed tagline

-03: Removed east elevation

-04:


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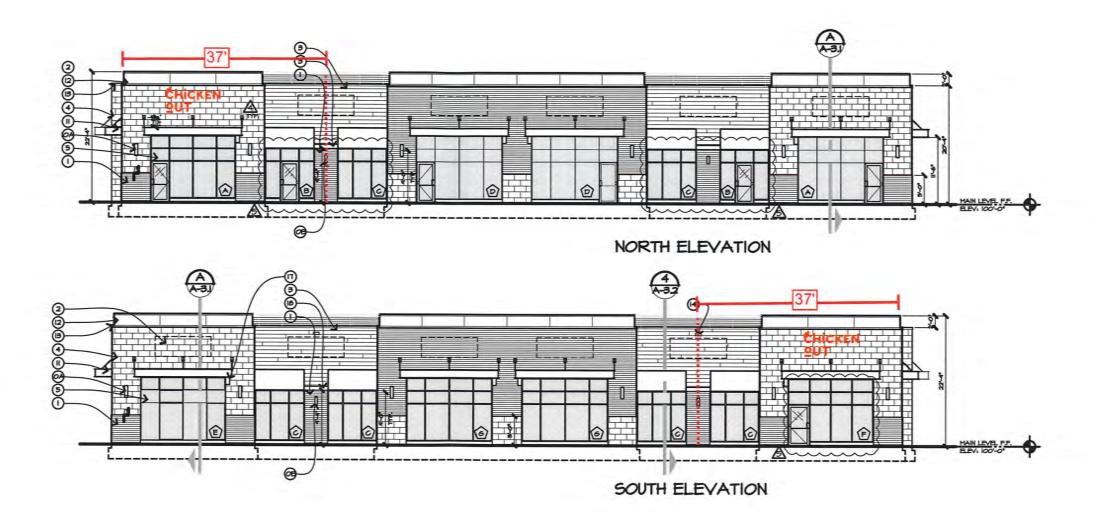


THE PROOF IS PRODUCED BY NOW YOU THEN HER MICHIGAN. A SEASON AND THE PROOF AND THE PRO

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SCALE: 1/16" = 1'



1818 HWY. M
BARNHART, MO 63012
PH: 636-464-0200
FAX: 636-464-9990
WWW.PIROSSIGNS.COM
GRAPHICS@PIROSSIGNS.COM

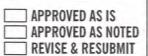CUSTOMER Chicken Out

JOB LOCATION Kirkwood, MO

CONTACT

SALES PERSON

David Brand, Jr.

DATE 5-25-21

DRAWN BY

Eric Irvin SAVED AS

211145 Chicken Out Kirkwood Wall Signs

RENDERING # 211145-03

REVISION(S)

-02: Removed tagline

-03: Removed east elevation signage

-04:

-05:

-06: -07:

-08:

-09:

-10:



INITIALS_


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(I) ELECTRI

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A.2 - Wall Sign


SCALE: 3/4" = 1'

PRODUCE & INSTALL 3 WALL SIGNS.

- · LED ILLUMINATED CHANNEL LETTERS
- ACRYLIC FACES W/ VINYL
- 1" TRIM CAP
- 5" DEPTH COLOR TBD
- RACEWAY MOUNTED COLOR TBD
- 43.125 SQ. FT. PER TOTAL 86.25 OF 87.5 PERMITTED SQ. FT. TOTAL DIVIDED BETWEEN 2 ELEVATIONS

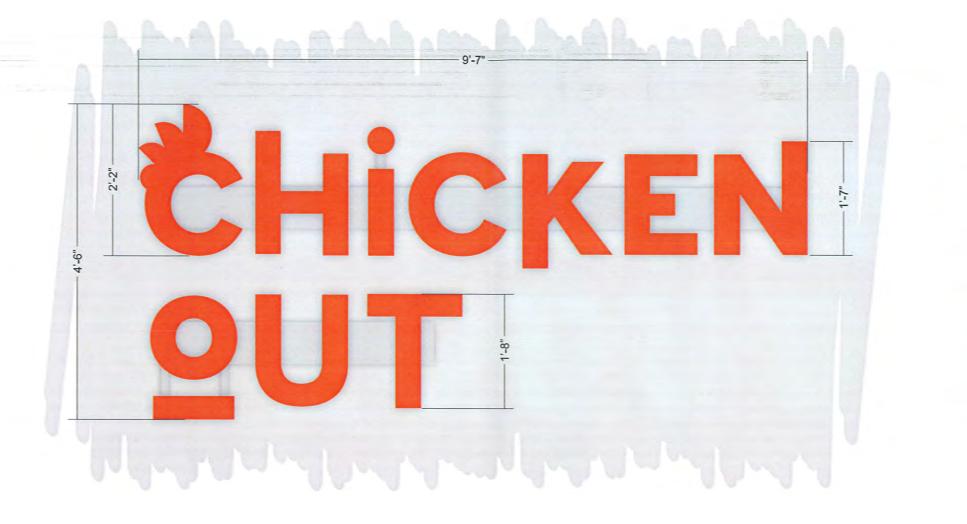PMS WARM RED

Raceway Install Guide L.E.D.

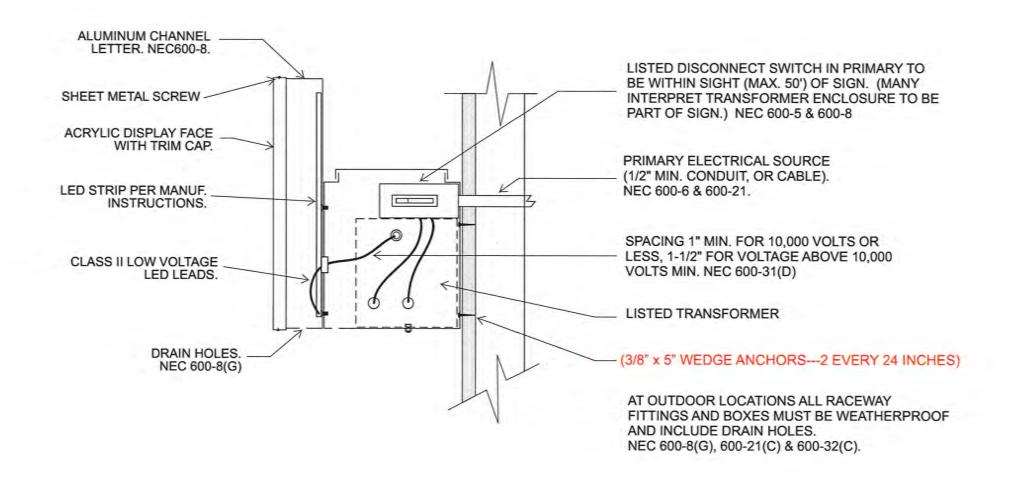



THE HOWARD COMPANY, founded in 1950, is an employee-owned point-of-purchase display manufacturer located in Brookfield, Wisconsin. We specialize in menu boards and food service products, as well as permanent and semi-permanent retail merchandising displays.



OVERVIEW

- The flexible design allows any combination of digital and static menu boards in the same housing, and placed how you prefer. You may want two digital menu boards and one static. Place the static flanked by the digital, or the digital screens next to each other with the static to one side.
- Revolutionary modularity allows you to upgrade as your business grows, even after installation with minimal interruption to drive-thru operations. You can start with a single door with the option to upgrade to the 3-door unit by swapping out the frame on site (keeping the base, the backing and hardware). If you have a 3-door static unit, you can upgrade to a digital with the flexibility to add one, two or three digital screens in the future. Upgrades can be done on site with only slight modifications to the housing backing.
- The dynamic heating and cooling system guarantees internal components are kept safely warm in severe cold and properly cooled in extreme heat.
- Screens are weatherproof, have a thin profile, and operate independently of each other for easy installation and maintenance.
- Ambient light sensors assure the information displayed is visible regardless of the time of day or weather.
- Ultra-thin 1/4" bezel and full 1080p HD screen offers clear viewing of menu content to edge of screen.
- Our Content Manager is a web-based interface that enables users to create, organize, manage and publish content to networks of displays. The solution supports all popular media formats, and provides real-time feedback and reporting.

FEATURES

- Easy two-person installation process
- Withstands pressure washing from any angle.
- Eliminates air conditioning to cool the systems.
- Practical modular design for quick repairs or maintenance.
- Wind load rated up to 180 mph.
- Light boxes and digital screens can be on separate power supplies

OPTIONS

- · 3 Digital Screens.
- 2 Digital Screens & 1 Static Graphic.
- 1 Digital Screen & 2 Static Graphics.




DRIVE-THRU DIGITAL SOLUTIONS


CONFIGURATIONS

- 1, 2 or 3 55" Optically bonded displays.
- · Optional Speaker/Mic Wing Cabinet.

SPECIFICATIONS

- · Ambient light sensors.
- · Aluminum and steel construction.
- Dynamic heating and cooling system keeps internal components safely warmed in extreme cold and properly cooled in extreme heat.
- · Modular Design.

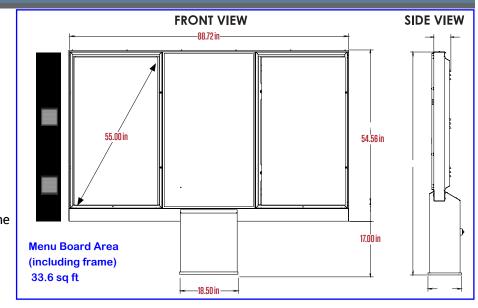

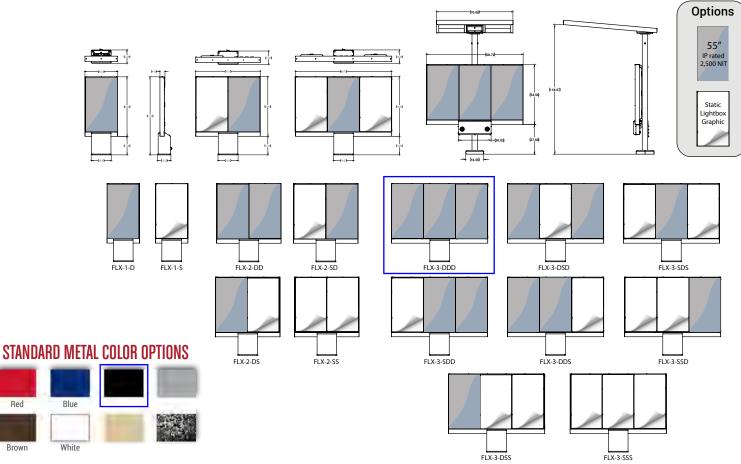







Architectural Review Board Application Additions & Detached Structures

DESIGN SUBMISSION APPLICATION

Property Address 445 N. Taylor Ave	Zoned R3
s the property a Kirkwood Landmark? Yes No	In a Local Historic District? Yes No
Complete scope of work Addition	
Construction Type/Fee: New House/\$150 Addition/\$	Accessory Structure or Other/\$100
APPLICANT	
Name Mike Lewis	Phone 314-226-3194
Address 204 Pecla Ava	
City, State, Zip / Luwood, MD 63122	
E-mail (Agenda will be e-mailed to applicant)	omestlegmand.com
PROPERTY OWI	NER (
Name Dan Angie McAlone	Phone 314 - 608 - 4977
Address 445 N. Taylor Ave .	
City, State, Zip Kirkwood, MO 63122	
ARCHITECT INFORM	MATION
Name Ann Begenago	Phone 314-614-0686
Address 3207 Charleston Blvd	品的。
City, State, Zip Rockingham, VA Z2801	
I agree to fully comply with the ordinances of the C Review, Zoning, Stormwater and Building regulations. on property for which I have the legal right to constru the proposed work, and that I have been authorized by their agent. Applicants or their representative shall at	I hereby certify that the project is located tot, that the owner(s) of record authorizes the owner(s) to make this application as tend all meetings. 3-28-2
Applicant's Signature	DECE Date
City Use Only	Date Stamp
Received by OW	MAY 2 8 2021
Agenda Date 06/21/21	
Case # 84-212	CITY OF KIRKWOOD
Permit # <u>22-881</u>	PUBLIC WORKS DEPARTMENT
Zoning Comments	
Building Comments	



Architectural Review Board Application Additions & Detached Structures


PROJECT DESCRIPTION WORKSHEET

Section A: General Information	
Nature of Application (Check all that apply):	
Addition or Alteration	
☐ Accessory Structure (Please Specify)	
☐ Other (Please Specify):	
Description of Work:	
Section B: Site Context	
1) Building Form and Articulation	
Architectural Style: Federal	
Number of Stories: Building Height	:Number of Roof Lines:
Roof Type: 30 Year Architectural	Primary Roof Pitch: 10:12
Secondary Roof Pitch: 12:12	Tertiary Roof Pitch: 8:12
2) <u>Building Materials</u>	
Primary Exterior Wall Material: <u>wood Sh</u>	ingle Shake
Secondary Exterior Wall Material:	
Tertiary Wall Material	
Primary Roof Material: 30 Year Arch	tectural
Secondary Roof Material:	
3) Exterior Windows and Doors	
Type of Door: Stained Wood doo	r
Type of Window: Aluminum Clad	Pane Arrangement:
4) <u>Detailing</u>	
Foundation Wall Covering:	
Location of Utility Equipment:	
Screening of Utility Equipment:	

Section C: Site Context Photos

Please attach to this application digital color photographs of all elevations of existing structures on the Subject Parcel. Photos must be a minimum 3"x4" size and may be on multiple pages:



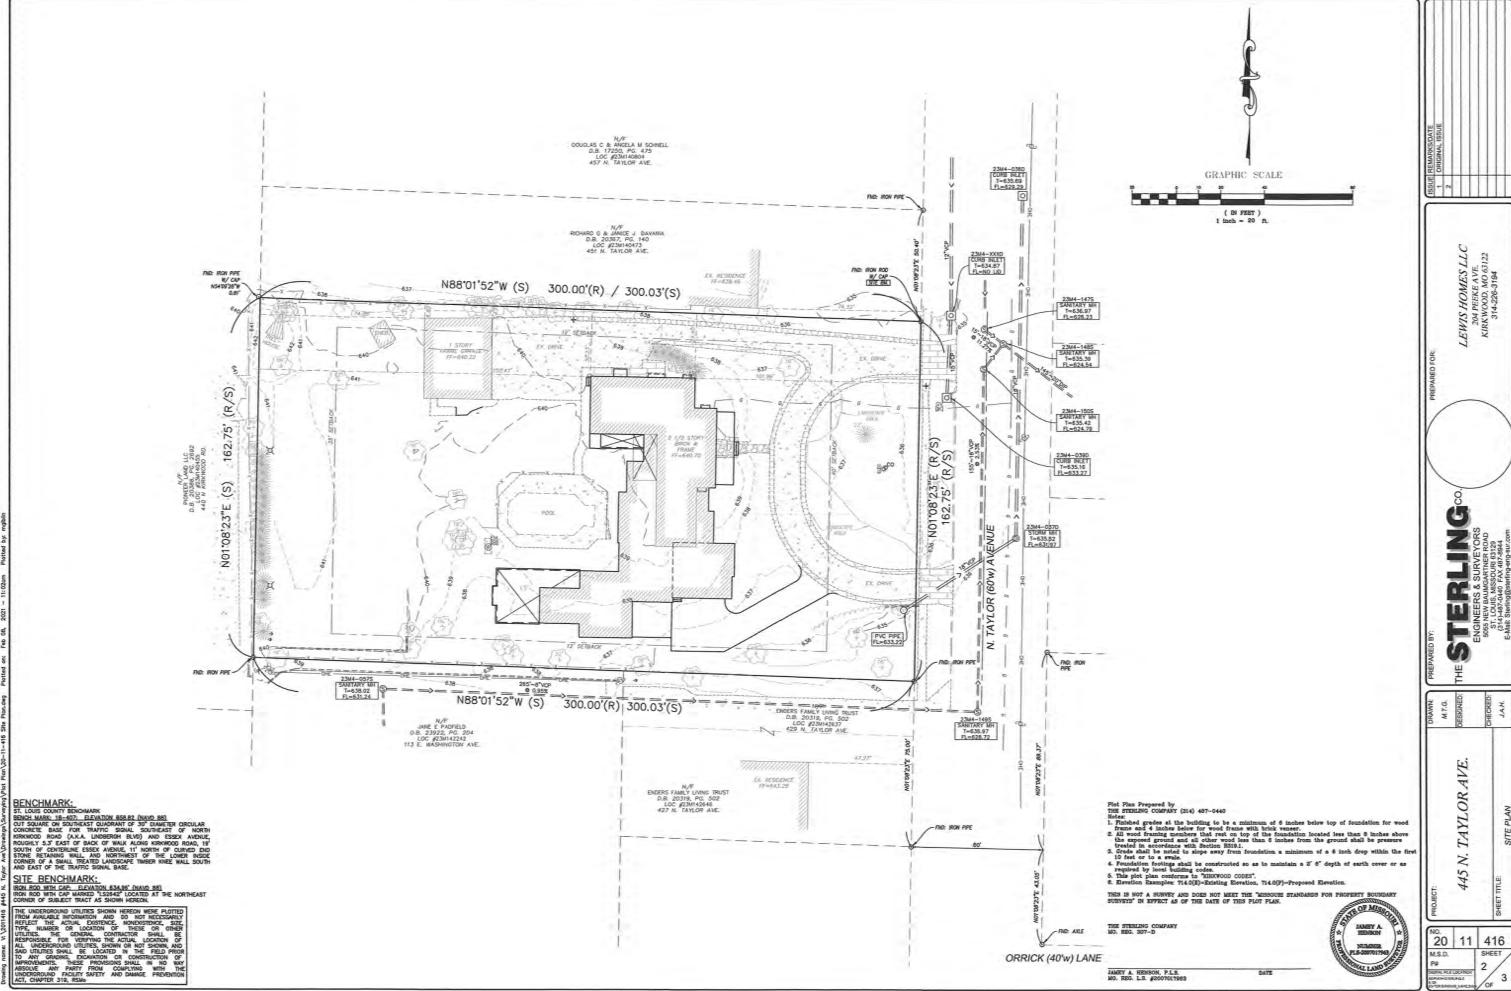

BASE MAP 24M

CONTRACTOR OF

GENERAL CONDITIONS:

1. The Commercian stress (SPRY ALL OSSIBLANDS ECONOMISS PRIOR TO STANDISCAR'S CONSTRUCTION HIS SHALL SCHINY THE ARCHITECT OF ANY DO NATIONAL SCHING STRE.

T. THE CONTROL TO MOVING MALE SUBSTITUTE FOR NOW & SECURE ALL APPROPERS BUILDING PERSONS FREE PERSONS TEST AND CORN E. THE SINEAGONG ON THESE SHAPINGS IN ALL CASES SUPERSEDE SCALE, CONTRACTOR IS NOT TO SCALE SHAPINGS.

RESIDENTIAL ADDITION TO THE MCALONE RESIDENCE 445 NORTH TAYLOR AVENUE KIRKWOOD, MO 63122

PROJECT DATA:

APPLICABLE CODES:

			9.8.607 to brance Pros		1	1		1		
	SERVIC DESCRI OUTESCRI	NECTICAL ING	PROST UNE DEPTH	TERMITE LIGHT TO	HINTER GESIGN TEUF.	CE SARRER UNCER- LAMENT REQUIRED	FLEOD HVZXROS	AR FRESDING INDEX	HEW HOUSE TELEP	
20 PSF	15 MEN	0	SEIERE	37	EW	78	10	3250/5	1500 CA15	St F

DESIGN:

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(1) EXISTING PHOTO









LEWIS HOMES 335 Leffingwell Avenue Suite 100 Kirkwood, MO 63122

NEW ADDITION to be CONSTRUCTED at the McAlone Residence 445 North Taylor Avenue Kirkwood, MO 63122


Ann Begemann, ARCHITECT begemann_ann@sbcglobal.net (314) 614-0686

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ARCHITECTURAL REVIEW BOARD DESIGN SUBMISSION APPLICATION

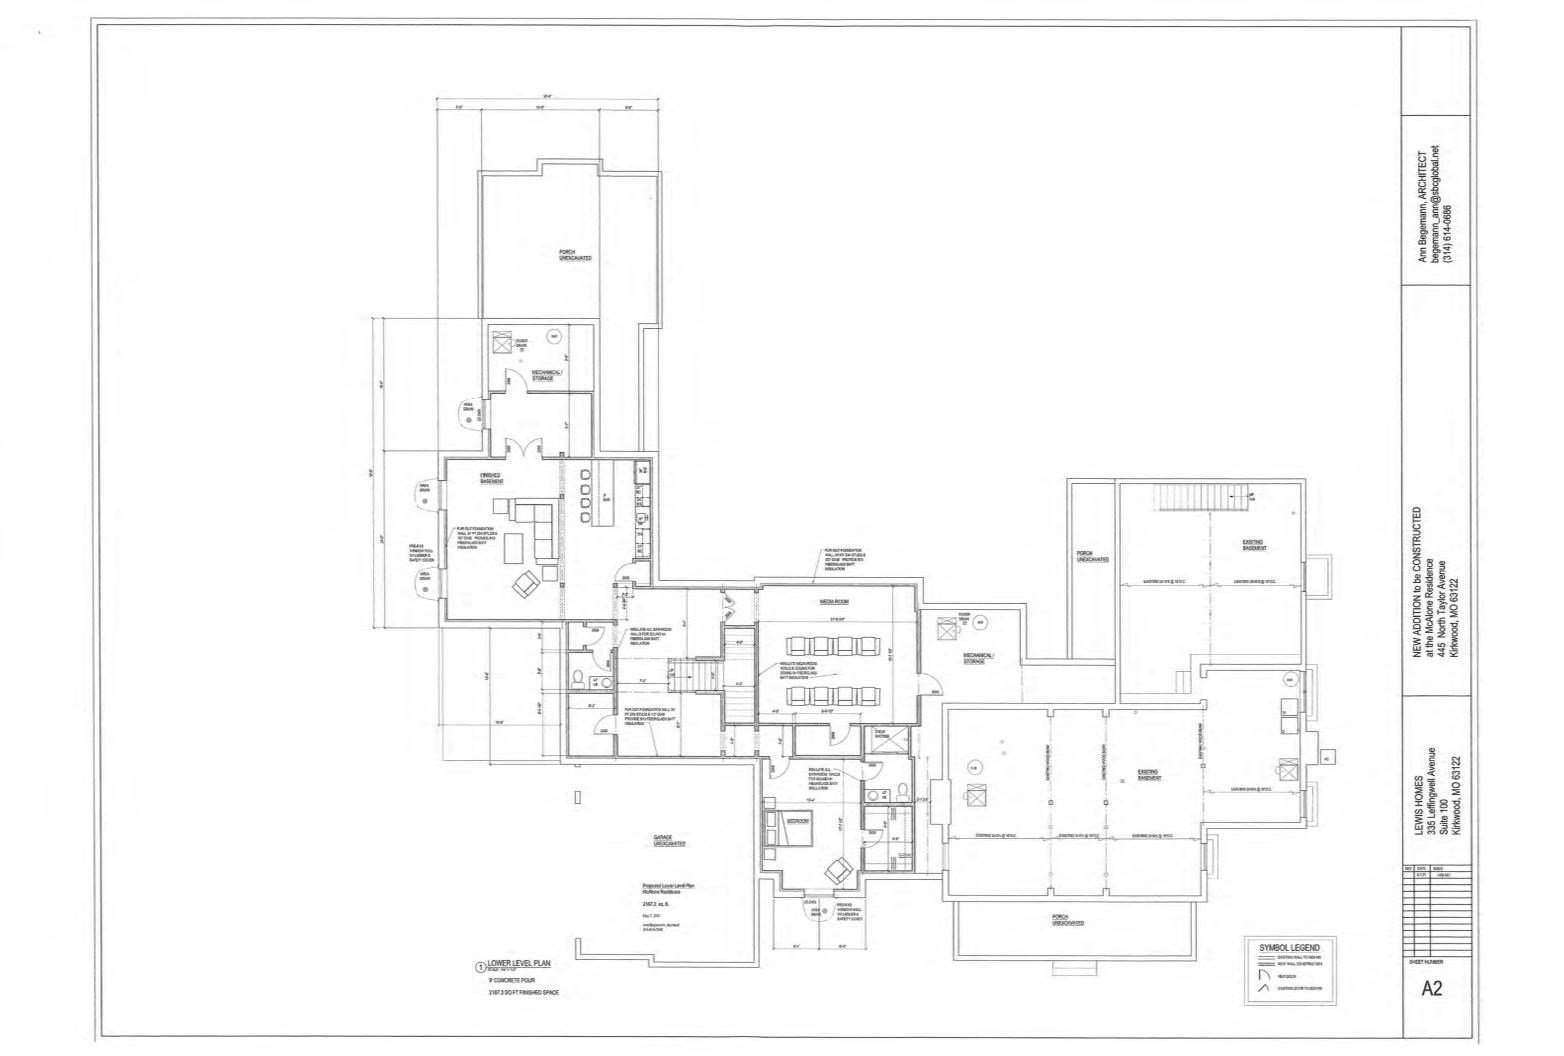139 S. Kirkwood Rd. Kirkwood, MO 63122 (314) 822-5816 Fax (314) 822-5898

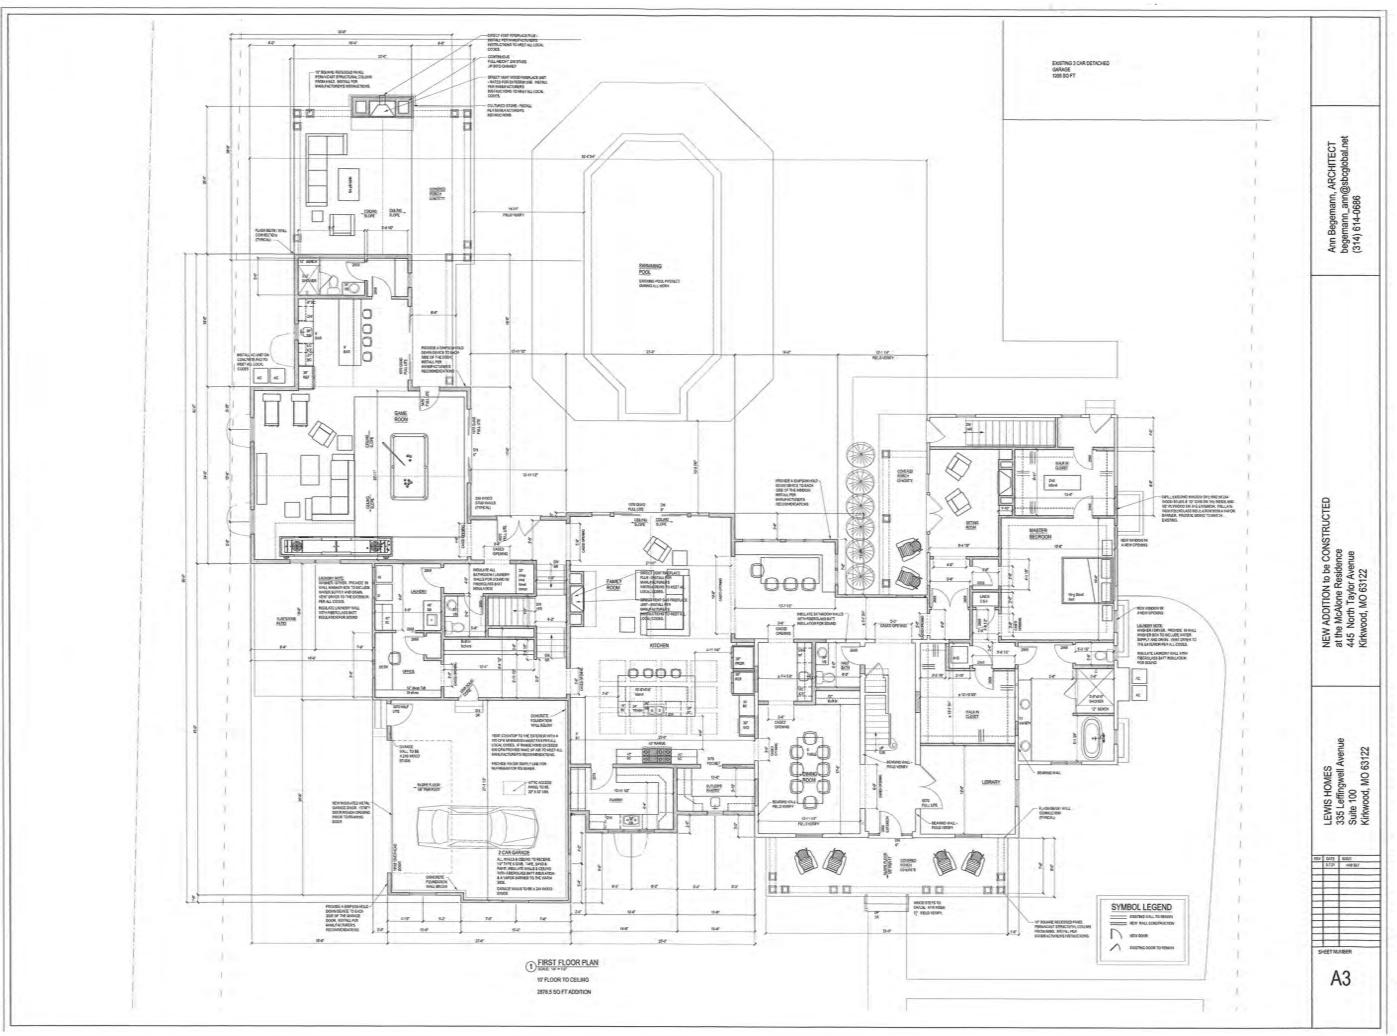

Meetings are held on the 1st and 3rd Mondays (excluding holidays) every month.

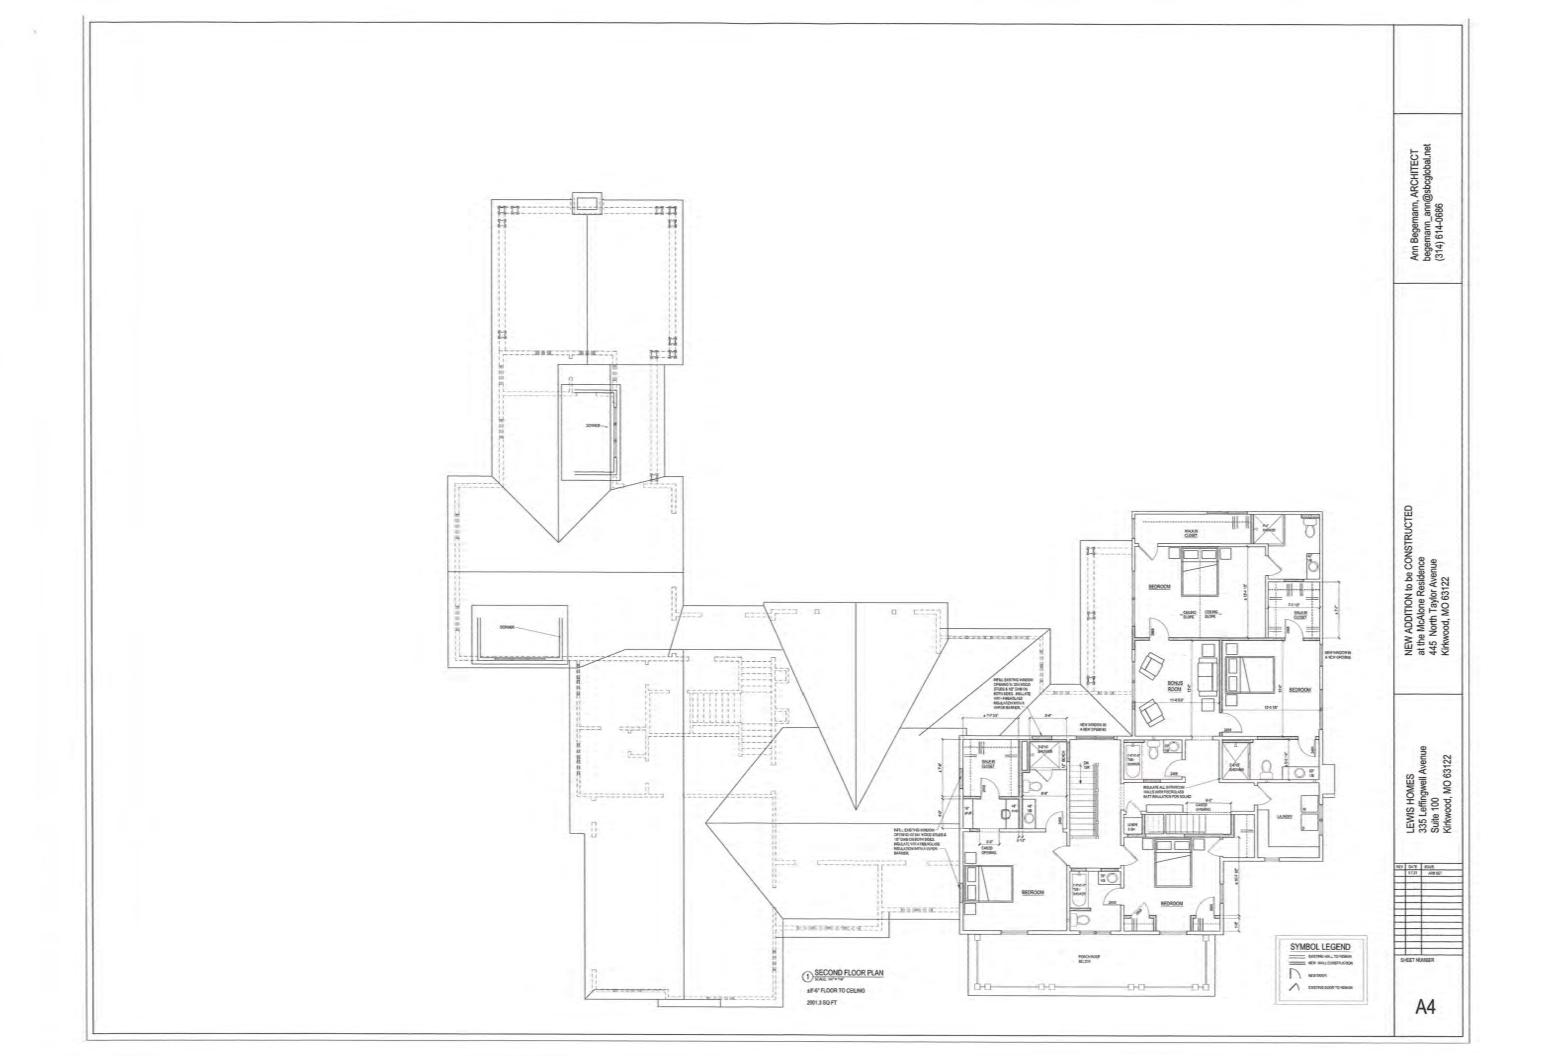Submittals must be turned in by 2: 00 p.m. on the deadline date.

See checklist for required submittal documents to accompany this application #22-903 Property Address 549 N Van Buren Case # 85-21 R Zoned R-4 Is the property a Kirkwood Landmark? Yes No In a Local Historic District? Yes No Scope of work - 2 Story Addition _____ Permit #_____ Construction Type/Fee: Addition - \$100.00 New House - \$150.00 Accessory Structure/All others - \$100.00 APPLICANT Name_ Naismith-Allen, Inc./Nathan Rauh Phone 314-556-0986 Address 130 A E. Lockwood City, State, Zip___Webster Groves, MO 63119 E-mail (Agenda will be e-mailed to applicant) nathan.rauh@naismith-allen.com **PROPERTY OWNER** Name Stephen Rastberger Phone 314-680-2933 Address 549 N Van Buren City, State, Zip_Kirkwood, MO 63122 ARCHITECT INFORMATION Name_Naismith-Allen, Inc./Nathan Rauh Phone_314-556-0986 Address___ 130 A E. Lockwood City, State, Zip Webster Groves, MO 63119 I have read the Architectural Review and Building regulations of the City of Kirkwood. I hereby certify that the project is located on property for which I have the legal right to construct. I hereby affirm the above statements are true and correct and agree to fully comply with the ordinances of Kirkwood. I hereby certify that the owner(s) of record authorizes the proposed work and I have been authorized by the owner(s) to make this application as their agent. Applicants or their representative shall attend all meetings. Applicant's Signature Received by Agenda Date 0 1/21/2021 City Use Only Zoning Comments____ Building Comments___

PROJECT DESCRIPTION WORKSHEET

Section A: General Information
Nature of Application (Check all that apply):
□ New Construction 🐹 Addition
□ Accessory Structure (Please Specify):
□ Other (Please Specify):
Description of Work: New rear 2 Story Addition
Section B: Neighborhood Context (New Construction & Additions)
<u>Material Palette:</u> Any material present on 20% or more of the front facades of existing houses within your Neighborhood Context is considered a Predominant Material (there may be more than one). If a single material is dominant on more than 70% of the houses within the site context that material is considered to be the Single Dominant Material.
Single Dominant Material: Stucco - matching existing
Predominant Material: Stucco - matching existing
Section C: Site Context
1.) Building Form and Articulation Architectural Style: Craftsman
Number of Stories: 2 Building Height: 20' +/- Number of Roof Lines: 2
Roof Type: Primary Roof Pitch:
Secondary Roof Pitch: Tertiary Roof Pitch:
2.) Building Materials Primary Exterior Wall Material: Stucco
Secondary Exterior Wall Material:
Tertiary Wall Material Asphalt Shingles
Primary Roof Material: Aspiral Shingles
Secondary Roof Material:
3.) Exterior Windows and Doors Type of Door: 6 panel
Type of Window: double hung Pane Arrangement: 3 over 1
4.) Detailing none Foundation Wall Covering:
Location of Utility Equipment:side
Screening of Utility Equipment:none

549 N VAN BUREN AVE.

2 STORY ADDITION

GENERAL NOTES

1. ALL MATERIALS & WORKMANSHIP SHALL COMPLY WITH 2015 IBC APPLICABLE LOCAL STATE, COUNTY, AND FEDERAL CODES. ORDINANCES, LAWS, REGULATIONS, AND PROTECTIVE COVENANTS GOVERNING THE SITE OF THE WORKIN THE CASE OF DIFFERENCE BETWEEN REQUIREMENTS, THE MOST STRINGENT SHALL GOVERN.

2. ALL MATERIALS & WORKMANSHIP SHALL COMPLY WITH ALL APPLICABLE SAFETY PROTOCOLS, INDUSTRY STANDARDS, UTILITY COMPANY REGULATIONS & THE MANUFACTURERS SPECIFICATIONS & RECOMMENDATIONS. IN THE CASE OF DIFFERENCE BETWEEN REQUIREMENTS, THE MOST STRINGENT SHALL GOVERN.

3. ALL TRADES SHALL FURNISH ALL LABOR, EQUIPMENT, MATERIALS, AND PERFORM ALL WORK NECESSARY INDICATED, REASONABLY INFERRED OR REQUIRED BY ANY CODE WITH JURISDICTION TO COMPLETE THEIR SCOPE OF WORK.

4. UNLESS NOTED OTHERWISE, PROVIDE AND PAY FOR ALL PERMITS AND CERTIFICATIONS AS ARE NECESSARY FOR THE FULFILLMENT OF THE WORK. GIVE ALL NOTICES AND COMPLY WITH ALL LAWS, BUILDING CODES, ORDINANCES, RULES & REGULATIONS BEARING ON THE CONDUCT OF THE WORK.

5. THE SITE HAS NOT BEEN SURVEYED OR FIELD VERIFIED. CONTRACTORS ARE RESPONSIBLE FOR CHECKING ALL FIELD CONDITIONS AND IMMEDIATELY REPORTING DISCREPANCIES AND ANY OTHER ISSUES TO THE OWNER/ARCHITECT.

6 ON SITE VERIFICATION OF ALL DIMENSIONS AND CONDITIONS SHALL BE THE RESPONSIBILITY OF THE SUB-CONTRACTORS.

7. THE GENERAL CONTRACTOR IS RESPONSIBLE FOR REQUESTING AND COORDINATING ALL BUILDING DEPARTMENT INSPECTIONS AND APPROVALS IN ALL FIELDS OF HIS/HER WORK AND THE OBTAINING OF THE FINAL "CERTIFICATE OF

8. ALL ELECTRICAL WORK BY DESIGN/BUILD ELECTRICAL CONTRACTOR, ALL MECHANICAL WORK BY DESIGN/BUILD MECHANICAL CONTRACTOR, ALL PLUMBING WORK BY DESIGN/BUILD PLUMBING CONTRACTOR.

9. CONTRACTORS ARE TO HAVE ON SITE AT ALL TIMES, THE APPROVED AND MOST CURRENT CONTRACT DOCUMENTS AND BUILDING PERMITS, INCLUDING APPROVED CHANGE ORDERS.

10. NOTED DIMENSIONS TAKE PRECEDENT OVER SCALING DRAWINGS. EACH SUB-CONTRACTOR SHALL REPORT TO THE ARCHITECT/OWNER ANY DISCREPANCY OR OTHER QUESTIONS PERTAINING TO THE WORKING DRAWINGS AND/OR

CODE DATA

PROJECT LOCATION: 549 N VAN BUREN AVE. KIRKWOOD, MO 63122

LOT SIZE/AREA:

135'/135' x 60'/60' +/- = 8,100 SF/0.185 AC. ±

BUILDING AREA:

PROJECT SCOPE 2 STORY ADDITION

CODE DATA: St. Louis County (as Amended)

2014 NEC and Ordinance #27430 2015 UPC and Ordinance #27424

2015 IMC and Ordinance #27619

2015 IRC and Ordinance #27654

2015 ECC as referenced by 2009 IRC and 2009 IMC

JUN 0 9 2021 PUBLIC WORKS DEPARTMENT

DRAWING INDEX





PHOTOS

C-1 STORMWATER PLAN STORMWATER DETAILS





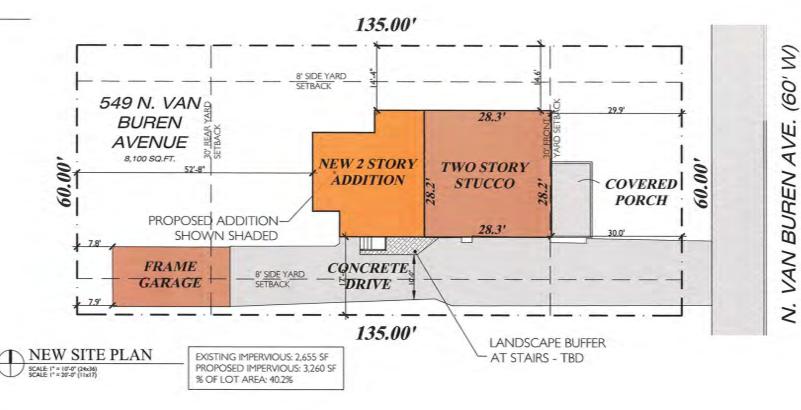

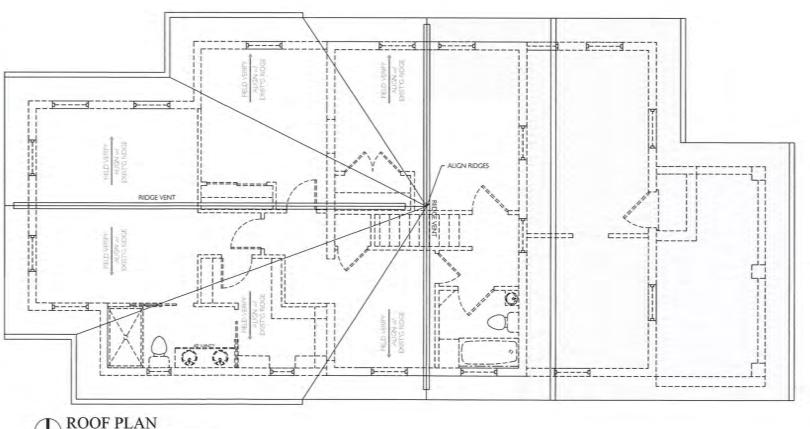

NAISMITH ALLEN 8949 RALEIGH. ST. LOUIS, MO 63123 314.556,0986

DATE: 06.01.21 CONTACT: Nathan Rauh

Ш S Ш K 4 Π B

ISSUE

DATE





A-2.01

549 VAN BUREN KIRKWOOD, MO 63122

DATE

NAISMITH ALLEN &



WEST ELEVATION - FRONT





ACROSS STREET - PROPERTY



EAST ELEVATION - REAR



ACROSS STREET - WEST ELEVATION



SOUTH ADJACENT - EAST ELEVATION





NORTH ADJACENT - EAST ELEVATION





DATE: 06.01.21 CONTACT: Nathan Rauh

RESIDEN Addition + Renovation to: STBERGER-PETRIE

PHOTOS

Architectural Review Board Application

Additions & Detached Structures

HOTE

ENTIRE FOOTPRINT

DESIGN SUBMISSION APPLICATION

SAME AS 1991

Property Address 1007 KRA	USWOOD DR	Zoned Zoned	KESIDENTIN
s the property a Kirkwood Landmark	? Yes No In a	Local Historic Di	strict? Yes No
Complete scope of work Simple	ENCLOSURE	OVER EX	ISTING DECK
Construction Type/Fee: New House/S	\$150 Addition/\$100	Accessory Struc	cture or Other/\$100
0	APPLICANT		Para Loonia
Name KOBERT & MAUREEN	KEED	Phone 314	966-4005
Address 1007 KRAUSWOOD			
City, State, Zip Kirkwood Mi	5 63122		
E-mail (Agenda will be e-mailed to applica	ant) mmr 715@h	otmail, cor	n
	PROPERTY OWNER		
Name ROBERT & MAUREE			
Address 1007 KRAUSWOOD	Drive (Pri	VATE ROAD)	
City, State, Zip Kirkwood, Mc			
	CHITECT INFORMATI		
Contract of the contract of th		- A 177 Y 1	
City, State, Zip			
agree to fully comply with the ord	inances of the City of	of Kirkwood, inclu	udina Architectur
Review, Zoning, Stormwater and Build	ding regulations. I he	eby certify that th	e project is locate
n property for which I have the lega he proposed work, and that I have be	l right to construct, the	nat the owner(s) o owner(s) to make	f record authorize this application a
heir agent. Applicants or their repres	(BENERIN) SERIO (CERENIN) CERENINA (CERENINA EL CONTROL DE CONTRO		tino application a
Court & Red As	An Road		6/4/2021
applicant's Signature	_ 111, 0,000		Date
City Use Only	i e	Pate Stamp	E/C
400	ID.	E G E I V	
Received by	15		
Agenda Date Co 21.22 Case # 69-21 B	JA L	JUN 0 4 2021	
Permit # 22 - 991			
All additions that the same of		CITY OF KIRKWOOD	147417
Zoning Comments			100
E CANTON E ANTON E			
Building Comments			



Architectural Review Board Application

Additions & Detached Structures

NOTE:

CANTILL FOOTSEIN

PROJECT DESCRIPTION WORKSHEET


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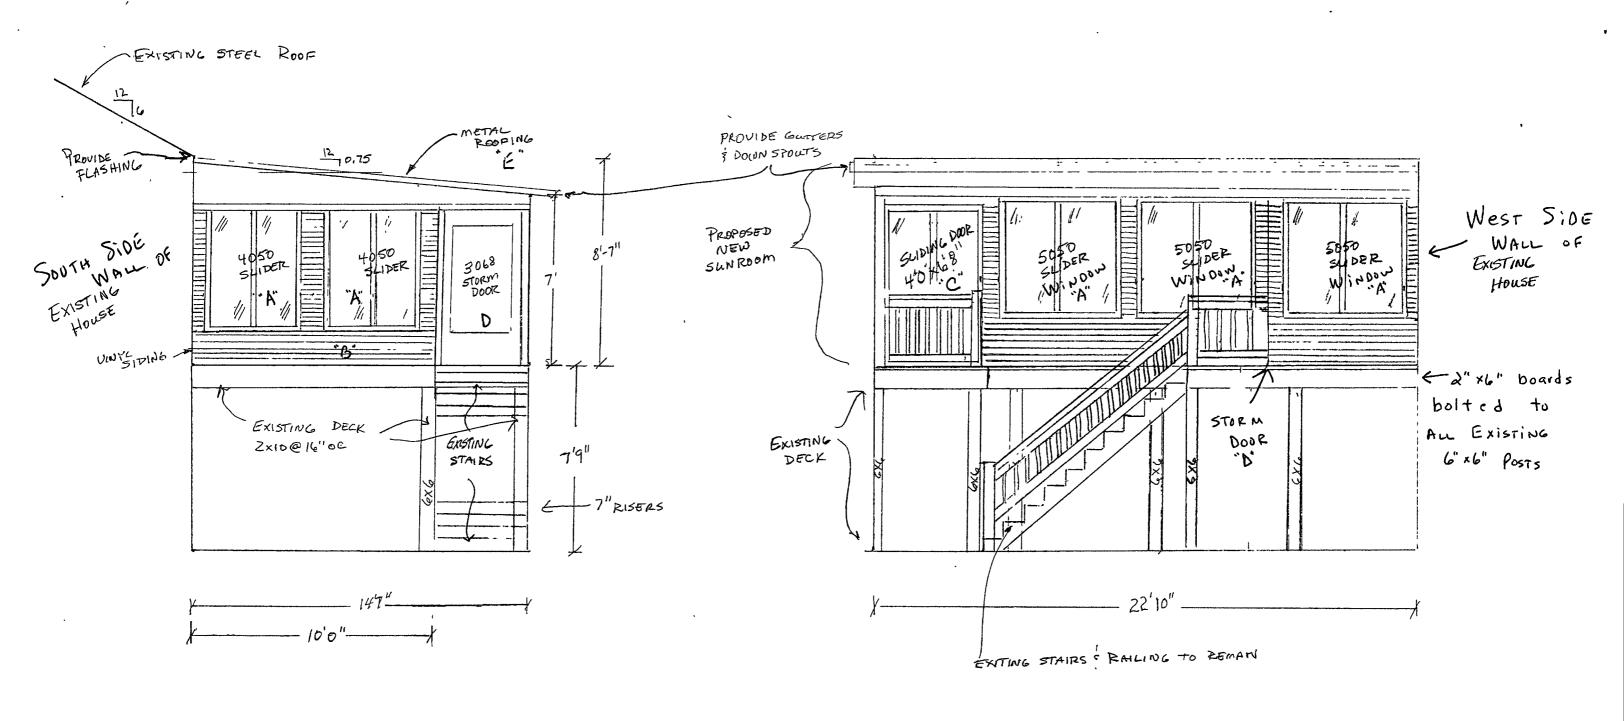
AS 1991

Section A: General Information
Nature of Application (Check all that apply):
Addition or Alteration Accessory Structure (Please Specify): Two sided enclosure to Exising Other (Please Specify): (west is south) Deck Description of Work: Shore existing deck install walls windows doors and siding more
Section B: Site Context existing south autter
1) Building Form and Articulation Architectural Style: RANCH
Number of Stories:
3) Exterior Windows and Doors Type of Door: 1-Sliding 1- STORM DOOR
Type of Window: 5' coache east Pane Arrangement: Dayble pane 4) Detailing
Foundation Wall Covering: NA
Location of Utility Equipment: NA
Screening of Utility Equipment:

Section C: Site Context Photos


Please attach to this application digital color photographs of all elevations of existing structures on the Subject Parcel. Photos must be a minimum 3"x4" size and may be on multiple pages:



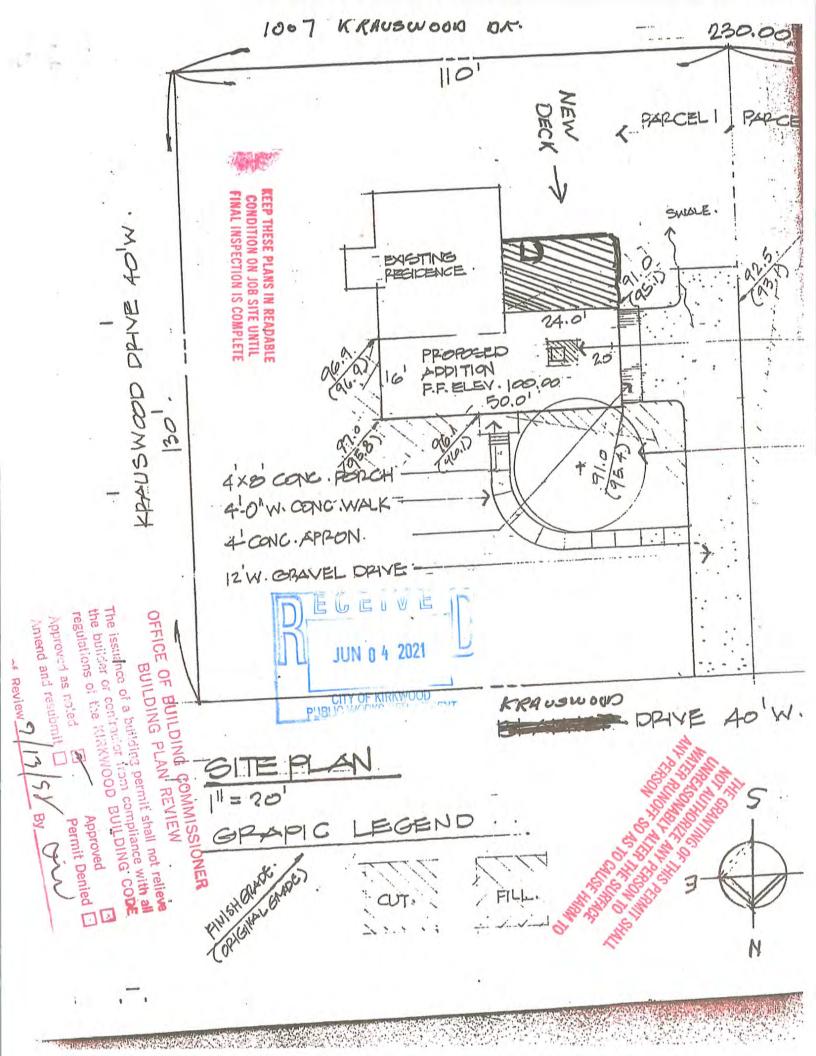

SCALE: 14"= | FOOT

REED
1007 KRAUSWOOD DR
ST. LOUIS, Mo 63122

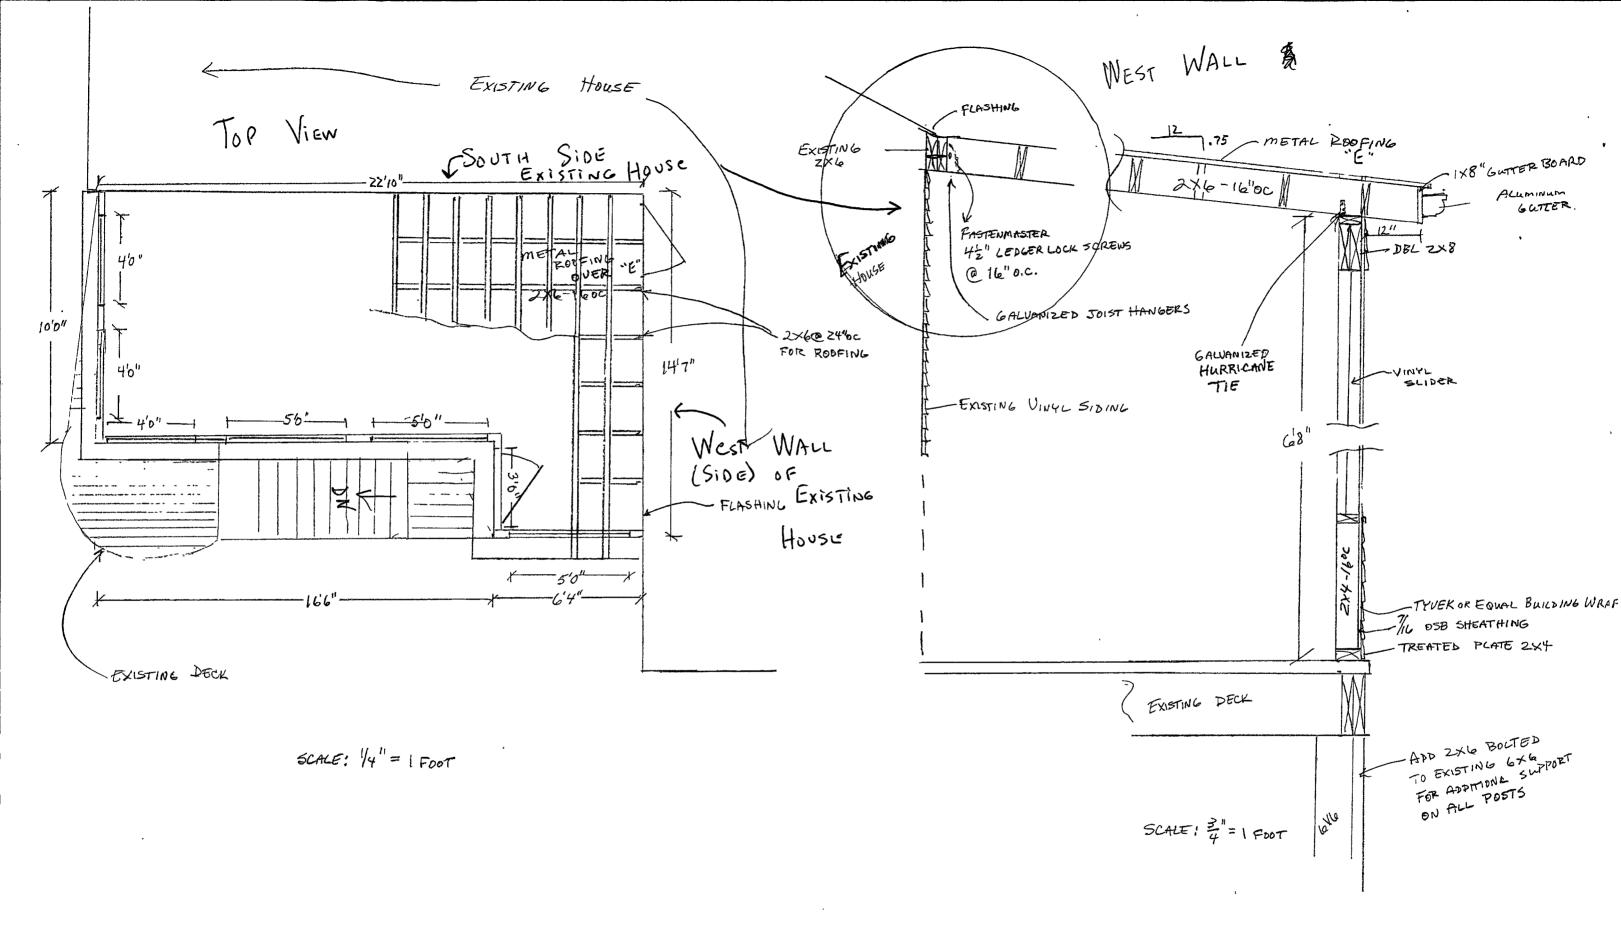

REED 1007 KRAUSWOOD DR ST. LOUIS, MO, 63122

Description & Documents

JELD-WEN viryl windows are made to be durable, energy efficient, and low-maintenance. With features like a steel-reinforced frame and insulated glass, JELD-WEN® vinyl windows are suitable for any architectural style or design. Backed by a Lifetime Limited Warranty, they're just as reliable as they are attractive!



MADE IN STATE OF THE STATE OF T

Shipping Dimensions: 62.25~H~x~62.25~W~x~3.50~DShipping Weight: 89.75~lbs

Click here to see more products from **JELD-WEN**

JELDWEN

Features

- · Vinyl construction allows for low maintenance
- Steel-reinforced sash for long-lasting strength
- Low-E glass with Argon reduces energy costs, interior condensation, and protects against harmful UV rays
- ENERGY STAR® certified windows reduce energy bills by an average of 12% nationwide, compared to non-certified products
- Built-in Brickmould and J-Channel frame creates a clean, streamlined appearance for a traditional look while also saving a step in the installation process
- Built-in nailing flange for complete installation and a tight seal
- · Left side sliding viewed from the outside of the house
- Half Screen Included
- · Vinyl white interior and exterior
- Accidental glass breakage coverage included for all of life's unexpected


Specifications


Product Type	Sliding Windows	Material	Vinyt
Collection	Better Series	Mounting Method	With Nailing Flange (New Construction)
Rough Opening Dimensions	60" W x 60" H	Frame Width	59-1/2 inches
Frame Height	59-1/2 inches	Frame Depth	3-3/32 inches
Screen Color	Gray	Screen Material	Fiberglass Mesh
Hardware Type	Nylon Rollers and Cam-Lock	Hardware Finish	White
Glazing Type	Double Pane	Interior Color	White
Exterior Color	White	Special Features	Screen, Brickmould, Low-E
Grid Pattern	No Grid Pattern	Air Leakage (AL) Rating	0.3 CFM
U-Value	0.3	Visible Light VT Rating	0.62
Energy Star Zones	Northern	Solar Heat Gain Coefficient	0.51
Listing Agency Standards	UL, AAMA, NFRC	Meets IRC for Egress	Yes
Manufacturer Warranty	Lifetime Limited, Accidental Glass Breakage Warranty, Skilled Labor Coverage - 2 years year	Return Policy	Regular Return (view Return Policy)

Please Note: Prices, promotions, styles and availability may vary by store and online. Inventory is sold and received continuously throughout the day; therefore, the quantity shown may not be available when you get to the store. This inventory may include a store display unit. Online orders and products purchased in-store qualify for rebate redemption. Mail-in Rebate is in the form of merchandise credit check, valid in-store only. Merchandise credit check is not valid towards purchases made on MENARDS.COM*. By submitting this rebate form, you agree to resolve any disputes related to rebate redemption by binding arbitration and you waive any right to file or participate in a class action. Terms and conditions available at www.rebateinternational.com.

MainStreet™ Triple 3" x 12' 1" Natural Clay Brushed Vinyl Siding

Model Number: 3913160 | Menards * SKU: 1480549

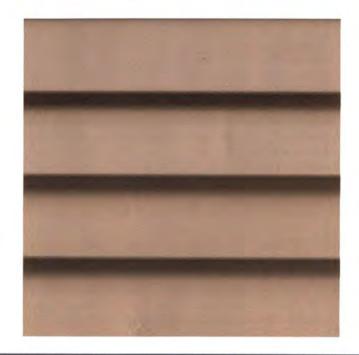

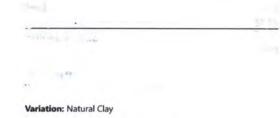

Increments of 11 may be required

* Mail-in Rebate is in the form of merchandise credit check, valid in-store only. Merchandise credit check is not valid towards purchases made on MENARDS.COM*.





FREE Ship To Store

Available for Special Order at <u>ST. PETERS</u>
Get it as soon as 08/01/2021



Delivery

Available

Description & Documents

MainStreet™ triple three-inch siding offers value with the benefits of a premium panel: a reinforced rolled-over nail hem, DuraLock™, and the STUDfinder™ installation system with a smooth, brushed finish for the look of freshly-painted wood. It's .042 inches thick.



Shipping Dimensions: $145.00 \text{ H} \times 9.00 \text{ W} \times 0.56 \text{ D}$

Shipping Weight: 4.4375 lbs

Brand Name: Mainstreet

Features

- Patented STUDfinder™ is designed for accurate and secure installation
- DuraLock® post-formed lock design
- RigidForm™ 160 technology has been tested to withstand wind load pressures up to 160 mph
- 11 pieces cover 100 sq ft
- Limited lifetime warranty
- · Smooth low gloss brushed finish
- 9/16" panel projection
- · Class 1(A) fire rating

Specifications

Siding Profile	Triple 3*	Color	Natural Clay
Thickness	0.042 inch	Material	Vinyl
Siding Surface Design	Brushed	Overall Width	9 inch
Overall Length	145 inch	Exposure	9 inch
Coverage Per Piece	9.06 square foot	Manufacturer Warranty	Limited Lifetime
Special Features	Class 1(A) Fire Rating	Maximum Wind Resistance	200 miles per hour
Listing Agency Standards	Class 1(A) Fire Rating	Return Policy	Special Order Merchandise (view Return Policy)

Specification Sheet



MainStreet TM

Vinyl Siding

General Description: MainStreetTM siding is appropriate for use in new construction for single family homes, multi-housing projects and light commercial developments. MainStreet is also an ideal product for remodeling.

Styles:

Profile	Finish	Panel Projection	Wall Thickness (Nominal)	Lock Design	Colors	Accessory Pocket
Double 4" Clapboard	Woodgrain	9/16"	.042"	Post-formed	24	1/2", 5/8" OT 3/4"
Double 4" Dutchlap	Woodgrain	9/16"	.042"	Post-formed	24	1/2", 5/8"or 3/4"
Double 5" Clapboard	Woodgrain	9/16"	.042"	Post-formed	24	1/2", 5/8" or 3/4"
Double 5" Dutchlap	Woodgrain	9/16"	.042"	Post-formed	24	1/2", 5/8" or 3/4"
Triple 3" Clapboard	Smooth Brushed	9/16"	.042"	Post-formed	11	1/2", 5/8"or 3/4"
Single 6-1/2" Beaded	Smooth Brushed	9/16"	.042"	Post-formed	13	1/2", 5/8" or 3/4"
Single 8" Clapboard	Woodgrain	5/8"	.042"	Post-formed	1	3/4"

Colors: MainStreet siding profiles are available in a wide selection of colors. All colors are Spectrophotometer controlled and utilize exclusive PermacolorTM color science.

Autumn Red	Colonial White	Forest	Light Maple	Sandstone Beige	Snow
Autumn Yellow	Cypress	Granite Gray	Natural Clay	Savannah Wicker	Spruce
Buckskin	Desert Tan	Hearthstone	Oxford Blue	Seagrass	Sterling Gray
Charcoal Gray	Flagstone	Heritage Cream	Sandpiper	Silver Ash	Suede

^{*}Color availability varies by profiles - check Product Catalog for detail.

STUDfinder™: The patented STUDfinder Installation System combines precisely engineered nail slot locations with graphics. Nail slots are positioned 16" on center to allow for alignment with studs. STUDfinder graphics centered at each slot provide a quick and easy guide to help locate studs.

RigidFormTM: MainStreet RigidForm 200 double nail hem technology stiffens siding for a straighter-on-the-wall appearance and provides wind load performance.

Lock: MainStreet's exclusive DuraLock™ is a substantially larger lock than is found on competing products, with a rigid teardrop shape and engineered angular locking leg for a positive, snap fit application and exceptional wind resistance.

Accessories: CertainTeed manufactures a wide range of siding accessories which are compatible with MainStreet siding styles and colors. Accessory products include installation components, soffit, window and door trim, corner lineals, corner systems and decorative moldings.

Composition: MainStreet siding products are produced using CertaVin™ custom-formulated PVC resin. This resin is produced exclusively by CertainTeed, allowing CertainTeed to maintain the high quality of its siding products.

Technical Data: MainStreet siding is in compliance with ASTM specification for Rigid Polyvinyl Chloride (PVC) Siding D 3679, and the requirements of section R703.11 of the International Residential Code, and section 1405.14 of the International Building Code. MainStreet siding meets or exceeds the properties noted in Table 1.

Table 1

ASTM E 84	Meets Class A flame spread requirements as tested according to ASTM E84.
ASTM D 1929	Self-ignition temperature 813°F
ASTM D 635	Material is self-extinguishing with no measurable extent of burn when tested in accordance with this specification.
NFPA 268	Radiant Heat Test - Ignition Resistance of Exterior Walls - Conclusion that CertainTeed met the conditions for allowable use as specified in section 1406 of the International Building Code.

Important Fire Safety Information: When rigid vinyl siding is exposed to significant heat or flame, the vinyl will soften, sag, melt or burn, and may thereby expose material underneath. Care must be exercised when selecting underlayment materials because many underlayment materials are made from organic materials that are combustible. You should ascertain the fire properties of underlayment materials prior to installation. All materials should be installed in accordance with local, state and federal Building Code and fire regulations.

Wind Load Testing: CertainTeed MainStreet double 4" siding has been tested per ASTM D 5206 standard test method for resistance to negative wind load pressures exceeding 55 psf, which equates to more than 200 mph(V_{ASD}) and 260mph (V_{ULT}), when installed with nails positioned 16" on center. Check with your local building inspector for wind load requirements in your area on the type of structure you are building.

Documents: CertainTeed Vinyl Siding meets the requirements of one or more of the following specifications.

Texas Department of Insurance Product Evaluation EC-11

Conforms to ASTM Specification D3679

Florida BCIS Approval FL1573

ICC-ES Evaluation Report ESR-1066

For specific product evaluation/approval information, call 800-233-8990.

Installation: Prior to commencing work, verify governing dimensions of building, examine, clean and repair, if necessary, any adjoining work on which the siding is in any way dependent for its proper installation. Sheathing materials must have an acceptable working surface. Siding, soffit and accessories shall be installed in accordance with the latest editions of CertainTeed installation manuals on siding and soffit. Installation manuals are available from CertainTeed and its distributors.

Warranty: CertainTeed supports MainStreet siding products with a Lifetime Limited Warranty including PermaColor Lifetime Fade Protection to the original homeowner. The warranty is transferable if the home is sold.

Technical Services: CertainTeed maintains an Architectural Services staff to assist building professionals with questions regarding CertainTeed siding products. Call 800-233-8990 for samples and answers to technical or installation questions.

Sample Short Form Specification: Siding as shown on drawings or specified herein shall be MainStreet™ Vinyl Siding as manufactured by CertainTeed Corporation, Valley Forge, PA. The siding shall have a .042" nominal thickness. Installation shall be in accordance with manufacturer's instructions.

Three-part Format Specifications: Long form specifications in three-part format are available from CertainTeed by calling our Architectural Services Staff at 800-233-8990. These specifications are also available on our website at certainteed.com.



Description & Documents

JELD-WEN® vinyl patio doors are made to be durable, energy efficient, and low maintenance. These vinyl patio doors are suitable for any architectural style or design. Plus, they're just as attractive as they are reliable! Every JELD-WEN® product is designed to create lasting value and style for your home, which is why this model is backed by a lifetime limited warranty.



Shipping Dimensions: 79.50 H x 59.50 W x 3.75 D

Shipping Weight: 165.0 lbs

Click here to see more products from JELD-WEN



Specifications



- · Features 3/4" tempered, clear, insulated glass for added safety in your home
- · Right or left operation is determined as viewed from the outside
- . Includes a matching white handleset for a firm, comfortable grip
- · Includes an integral nailing flange for faster installation and a tight seal
- · Sliding screen door included
- · Backed by a lifetime limited warranty and made in the USA

Screen Included	Yes	Air Leakage (AL) Rating	0.1
Product Type	Sliding Patio Door	Door Material	Vinyl
Door Handing	Left Sliding	Listing Agency Standards	UL, AAMA, NFRC
Exterior Color	White	Frame Material	Vinyl
Glass Type	Double Pane	Hardware Finish	White
Includes	Screen Included	Interior Color	White
Rough Opening Height	80 inch	Rough Opening Width	60 inch
Screen Color	Charcoal	Screen Material	Fiberglass Mesh
Solar Heat Gain Coefficient	0.65	U-Value	0.47
Manufacturer Warranty	Limited Lifetime	Weight	165 pound
Nominal Door Width	60 inch	Nominal Door Height	80 inch
Return Policy	Special Order Merchandise (view Return Policy)		


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JELD-WEN® Builders Series 60"W x 80"H White Vinyl Left Hand Sliding Patio Door

Model Number: MENOLJW156200092 | Menards * SKU: 4214552



Door Operation: Left Hand Sliding

* Mail-in Rebate is in the form of merchandise credit check, valid in-store

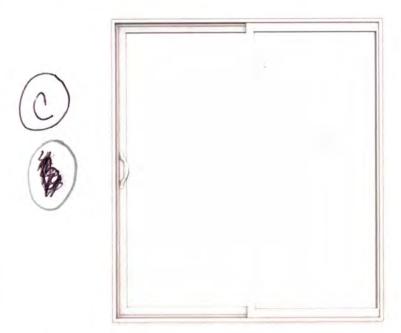* Mail-in Rebate is in the form of merchandise credit check, valid in-store only. Merchandise credit check is not valid towards purchases made on MENARDS.COM*.



FREE Ship To Store

Available for Special Order at <u>ST. PETERS</u>

Get it as soon as 07/17/2021



Delivery Available

WALLS: 2X4 WW STUDS @16" O.C. W/ 1/6 OSB SHEATHING W/ TYVEK OR EQUAL HOUSE WRAP W/ VINYL SIDING

Description & Documents

Invite in the breeze with the Timberline Screen Away® retractable screen storm door. The Screen Away design converts your storm door to a screen door instantly and the screen rolls up and hides when not in use.



Shipping Dimensions: 84.19 H x 36.81 W x 1.81 D

Shipping Weight: 70.0 lbs



Brand Name: Larson



Features

- Screen Away® retractable screen disappears into top cassette when not in
 use; balanced window system and ergonomic handle moves the screen up
 and down to ventilate
- Color-matched adjustable speed closer provides dependable closing without slamming for your convenience
- Patented Secure Lock® handle set includes a built-in latch and matching handles
- · Maintenance-free DuraTech® surface over a solid core
- · Designer screw covers conceal exterior screws for a finished look
- Reversa-Hinge allows for right or left hinge installation
- · EasyHang® installation system installs in half the time with no cutting
- . This item is not for sale to these states: HI, AK

Specifications



Please Note: Prices, promotions, styles and availability may vary by store and online. Inventory is sold and received continuously throughout the day; therefore, the quantity shown may not be available when you get to the store. This inventory may include a store display unit. Online orders and products purchased in-store qualify for rebate redemption. Mail-in Rebate is in the form of merchandise credit check, valid in-store only. Merchandise credit check is not valid towards purchases made on MENARDS.COM. By submitting this rebate form, you agree to resolve any disputes related to rebate redemption by binding arbitration and you waive any right to file or participate in a class action. Terms and conditions available at www.rebateinternational.com.

Larson® Timberline ScreenAway® 36"W x 80"H White Retractable Screen Highview Storm Door Model Number: 691-52_36X80_Nickel_White | Menards ® SKU: 4152366







Pick Up At Store

3 In-Stock at <u>ST. PETERS</u> Check Another Store for Availability



Shipping & Delivery

Available





OUR STEEL MEASURES UP, DO OTHERS?

- •Pro-Rib .0165" nominal thickness
- •Premium Pro-Rib and Premium Pro-Snap- .018" nominal thickness
- Many companies boast a thick gauge panel. Gauge is not a measurement, to verify actual thickness measure with a micrometer.
- •A micrometer measures in thousandths of an inch and is the only way to know actual panel thickness. The difference between 26 and 29 gauge is less than the thickness of a sheet of paper. Testing shows this difference is not enough to change the strength properties in a panel.

"Builders need to stop thinking in terms of gauge and start thinking in terms of actual decimal thickness."
-Don Switzer, Steel Dynamics Sales Manager (Rural Builder Magazine-September 2016)

HARDNESS

THICKNESS

- Pro Rib, Premium Pro Rib, and Pro Snap are all 100,000 p.s.i. nominal tensile strength
- •Companies selling a 26 gauge panel, use a 60,000 p.s.i. tensile strength.
- •Our 28 gauge panel (Premium Pro-Rib) with 100,000 p.s.i. nominal strength has 25% more strength than the thicker panel.
- •Hail and Dent resistance is determined by the hardness of the panel. Testing shows hardness delivers the most *VALUE* to the owners.

ZINC &PAINT

- Pro-Rib has a G-60 and Premium Pro-Rib and Pro-Snap have a G-100 Galvanized Coating plus Zinc Phosphate
- Pro-Rib has a Limited 40 Year Paint Warranty while Premium Pro-Rib and Pro-Snap have a Limited Lifetime Paint Warranty.
- Menards has the most extensive testing to make sure the metal thickness, tensile strength and coatings are correct.
- •Advances in Coatings make our steel longer lasting than ever! Our high quality paint systems provide the best warranties in the business. Coatings are the most important factor in panel lifespan.

MENARDS HAS THE BEST TESTING PROGRAM IN THE BUSINESS, PERIOD. THIS PROVIDES THE BEST PERFORMING PANEL YOU CAN GET.

DESCRIPTION & DOCUMENTS

Architectural steel panels have a Menards® exclusive pattern that uses a triple paint system to create the appearance of depth for an architectural shingled look with the benefits of a steel panel. Premium Pro-Rib® is one of the most versatile members of the Pro-Rib® family of quality products. It's truly a premium wall and roof panel whose applications span a tremendous variety of residential, commercial, and industrial construction projects. The superior performance of the Premium Paint System sets this panel apart from the crowd. All Pro-Rib® products are manufactured to the highest industry standards. Pro-Rib® is an environmentally friendly product.



Shipping Dimensions: 240.00 H x 38.00 W x 0.75 D Shipping Weight: 73.875 lbs

Brand Name: Premium Pro-Rib Architectural



Features

- · Panel features a painted design that mimics the look of architectural shingles
- · Panel covers a 36" width
- Custom cut lengths from 2' to 36' in 1" increments available special order in Menards store and Menards.com
- Actual .0157" minimum thickness before painting .018" nominal thickness after painting
- · G100 galvanization 66% more than 40-year paint warranty panels
- Manufactured from structural strength ASTM-A653, grade 80 steel
- Superior hail resistance (Class 4), Class A Fire Rated, 200 MPH wind resistance, properly installed steel panels will withstand devastating winds
- · Through fastener panel system, faster installation than shingles
- · Limited Lifetime paint warranty, and Energy Star Rated
- All steel over 36' to 50' must be ordered at a Menards® store and delivered directly to the jobsite or picked up at the plant in Eau Claire, WI; Holiday City, OH; or Valley, NE. Delivery is extra. Additional packaging/handling charges required. Exposed fastener/premium pro-rib price is figured on 38" nominal width.
- · Weighs approximately 74 lbs per 100 sq ft
- Trim colors that complement the Desert Tan Architectural Steel are Brown and Chocolate

Specifications

Product Type	Steel Panel	Material	Steel
Manufacturer Warranty	Limited Lifetime	Color/Finish	Desert Tan
Overall Width	38 inch	Overall Length	Custom inch
Coverage Per Piece	Varies by size ordered square foot	Rib Spacing	9 inch
Minimum Slope	3/12	Rib Height	3/4 inch
Thickness	0.018 inch	Return Policy	Special Order Merchandise (view Return Policy)

Please Note: Prices, promotions, styles and availability may vary by store and online. Inventory is sold and received continuously throughout the day; therefore, the quantity shown may not be available when you get to the store. This inventory may include a store display unit. Online orders and products purchased in-store qualify for rebate redemption. Mail-in Rebate is in the form of merchandise credit check, valid in-store only. Merchandise credit check is not valid towards purchases made on MENARDS.COM®. By submitting this rebate form, you agree to resolve any disputes related to rebate redemption by binding arbitration and you waive any right to file or participate in a class action. Terms and conditions available at www.rebateinternational.com/.





Pricing available after measurements are entered

Variation: Desert Tan

Additional Packaging/Handling Charges May Apply.



Shipping & Delivery

Available

Local Utility Rebates

Up to \$27.10 in Local Utility Rebates

Rebate information provided by EcoRebates


















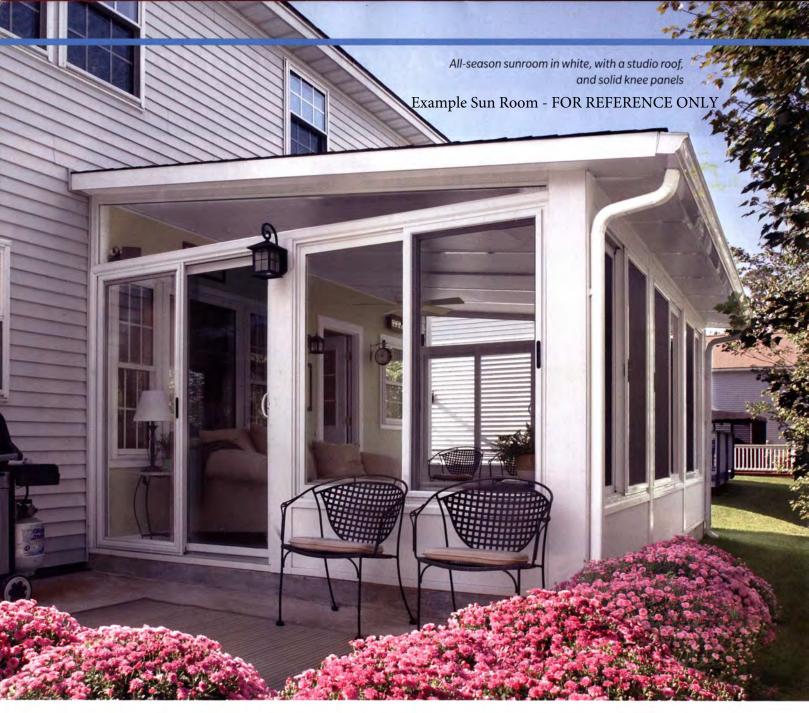



Architectural Review Board Application New Single Family Residence (SFR)

DESIGN SUBMISSION APPLICATION

Property Address 411 West Adams	Zoned R-4
s the property a Kirkwood Landmark? Yes No	In a Local Historic District? Yes No
omplete scope of work This project includes a new two story frame resid	dence with four bedrooms and 2.5 baths and an attached two car garage.
onstruction Type/Fee: New House/\$150 Additi	on/\$100 Accessory Structure or Other/\$100
APPLICA	
Name Michael E. Blaes, AIA	Phone (314) 968-9202
Address 643 Glen Road	
City, State, Zip Webster Groves, MO 63119	
E-mail (Agenda will be e-mailed to applicant) mike@blaes	design.com
PROPERTY O	OWNER
Name Matt Midden - STL Homebuyers, LLC	Phone (314) 783-6842
Address 34 North Brentwood Blvd, suite 205	
City, State, Zip_Clayton, MO 63105	
ARCHITECT INFO	DRMATION
Name_Michael E. Blaes, AIA	Phone (314) 968-9202
Address 643 Glen Road	
City, State, Zip Webster Groves, MO 63119	
agree to fully comply with the ordinances of the eview, Zoning, Stormwater and Building regulation property for which I have the legal right to consider proposed work, and that I have been authorized their agent. Applicants or their representative shall populate the proposed with the property of their representative shall populate the property of t	ns. I hereby certify that the project is locate struct, that the owner(s) of record authorized by the owner(s) to make this application
Received by Agenda Date 6 21-21 Case # 92-21 R Permit # 22-1009 Zoning Comments	JUN 0 7 2021 CITY OF KIRKWOOD PUBLIC WARPEN DEPOSITE
Building Comments	



Architectural Review Board Application New Single Family Residence (SFR)

PROJECT DESCRIPTION WORKSHEET

Section A: General Information				
Nature of Application (Check all that	at apply):			
☑ New Single Family Residen	ce			
☐ Accessory Structure (Please	e Specify):			
□ Other (Please Specify):				
Description of Work: This project includes a new two story frame residence with four bedrooms and 2.5 baths and an attached two car garage.				
Section B: Site Context				
1) Building Form and Articulation				
Architectural Style: Folk Victorian	Vernacular Revival			
Number of Stories: 2Buildi				
Roof Type: Gable	Primary Roof Pitch: 9:12			
Secondary Roof Pitch: 7 5/8:12	Tertiary Roof Pitch: 4 1/2:12			
2) Building Materials				
Primary Exterior Wall Material: Vin	yl Lap Siding			
Secondary Exterior Wall Material: F	Fiber Cement Board and Batten Siding			
Tertiary Wall Material				
Primary Roof Material: Architectura	l Asphalt Shingles			
Secondary Roof Material:				
3) Exterior Windows and Doors				
Type of Door: Fiberglass				
Type of Window: Vinyl	Pane Arrangement: 2 over 2			
4) Detailing				
Foundation Wall Covering: None				
Location of Utility Equipment:				
Seetien C. Neimblecher d.C.	4 (N) Paris			
	t (New Primary Construction Only)			
your Neighborhood Context is consi single material is dominant on more considered to be the Single Domina				
Single Dominant Material: Vinyl Sic	ding			
Predominant Material: Brick				



425 West Adams

419 West Adams

415 West Adams



411 West Adams



304 North Van Buren



303 North Van Buren



337 West Adams



448 West Adams



444 West Adams



450 West Adams



340 West Adams



342 West Adams



344 West Adams




404 - 418 West Adams









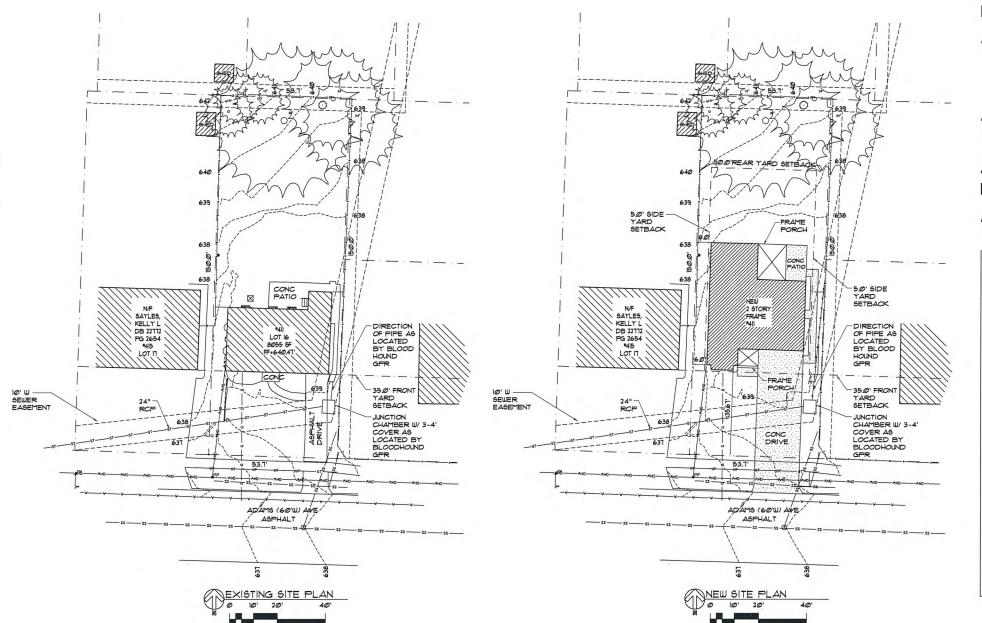

New Single Family Residence for:

DEVELOPMENT GROUP, LLC

411 West Adams Kirkwood MO, 63122

Architectural Review Board Set: June 7, 2021

DRAWING INDEX

ARCHITECTURAL

ARCHITECTURAL SITE PLANS

FOUNDATION PLAN A-1 BASEMENT PLAN

A-2 FIRST FLOOR PLAN A-3

A-4

FRAMING PLAN SECOND FLOOR PLAN A-5

A-6

ROOF PLAN ELECTRICAL PLANS A-7 A-8 **ELEVATIONS**

A-9 ELEVATIONS

A-10 WALL & PORCH SECTIONS & DETAILS

A-11 **SECTIONS & DETAILS**

A-12 A-13

CIVIL

SITE PLAN

DRAINAGE AREA MAP SITE DETAILS

C1 C2 C3







Michael E. Blaes - Architect
MO # A-6158 CERTIFICATE OF AUTHORITY #2016000.
NOTICE OF SHARED PROPERTY
MICHAEL E. BLAES, ARCHITECT OF REO
IS NOT RESPONSIBLE FOR INTERPRETATION.

Drawn By: TS/BE

Checked By:

Drawing Name:

Existing Site Plan New Site Plan


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C-1



Date: June 7, 2021 A REVISION (DATE-BY):

MesidenceHomebuyers,411 West Adams AvenueKirkwood, MO 63122

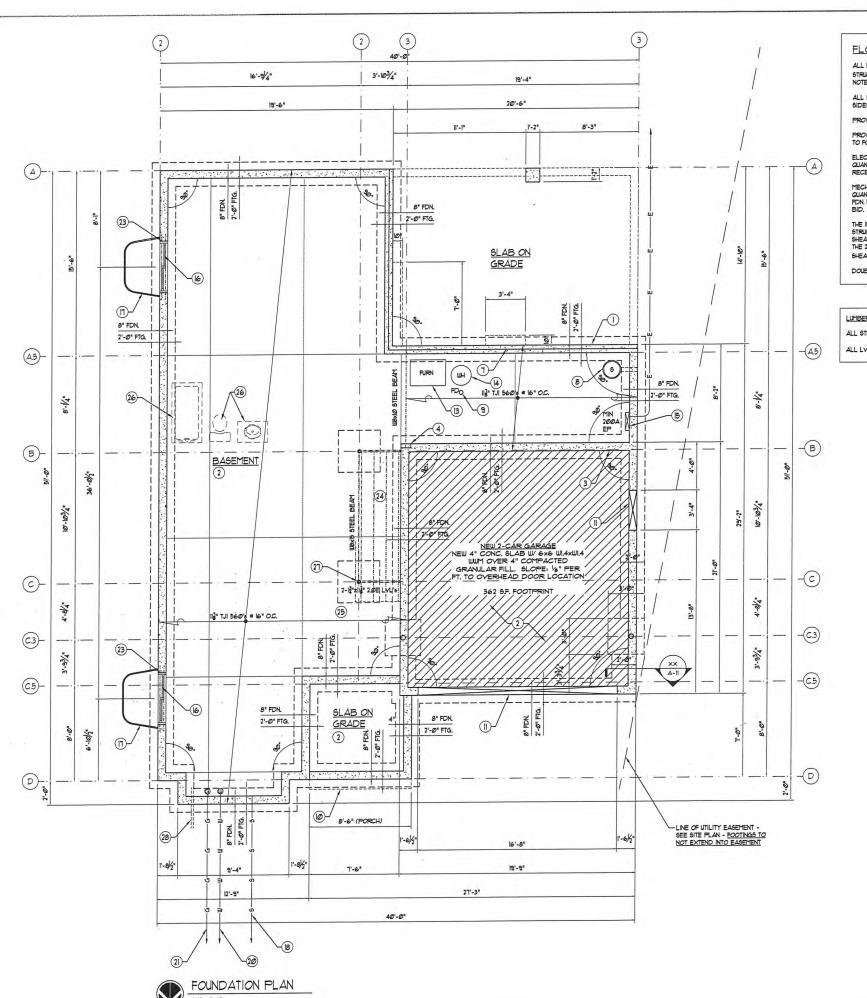

FLOOR PLAN NOTES:

ALL EXTERIOR WALLS 2x4 WOOD STUDS . 16" O.C. W 1" WOOD STRUCTURAL PANELS ONE SIDE 4 1" GUB ONE SIDE UNLESS OTHERWISE

ALL INTERIOR WALLS 2x4 WOOD STUDS @ 16" O.C. W V_2 " GWB BOTH SIDES UNLESS OTHERWISE NOTED

PROVIDE DOUBLE JOISTS UNDER WALLS PARALLEL TO JOIST SPANS

PROVIDE SOLID BLOCKING BENEATH GIRDER TRUSS BEARING POINTS TO FOUNDATION OR STEEL BEAM BELOW

ELECTRICAL CONTRACTOR TO COORDINATE FINAL LOCATION & GUANTITY OF ALL LIGHTS, FANS, RECEPTACLES, SUITCHES AND FLOOR RECEPTACLES WITH THE CUNER PRIOR TO SUBMITTING BID.

MECHANICAL CONTRACTOR TO COORDINATE FINAL LOCATION (
GUANTITY OF ALL SUPPLY DUCTS (SIZE OF ANY PENETRATIONS THRU
FIDN WALLS (ROUTING OF SUPPLY/RETURN DUCTS PRIOR TO SUBMITTING
BID.

THE INTERIOR AND EXTERIOR WALL CONFIGURATION BRACES THE STRUCTURE IN ACCORDANCE WITH OR EQUIVALENT TO THE CONTINUOUS SHEATHING METHOD WITH COPIER FRANKING OF SECTION REGIZED ALOF THE 2008 EDITION OF IRC. (ALL EXTERIOR WALLS TO BE CONTINUOUSLY SHEATHED WITH I WOOD STRUCTURAL PANELS)

DOUBLE FLOOR JOISTS BENEATH PARTITIONS ABOVE

LUMBER NOTE:

ALL STRUCTURAL & FRAMING LUMBER TO BE MIN I GRADE SYP OR BETTER

ALL LVL'S MIN. 3/" BEARING UNLESS OTHERWISE NOTED

- (3) TOP OF FOUNDATION WALL MIN 4" ABOVE GARAGE SLAB
- 4) BEAM POCKET GROUT SOLID LEVEL W/ STEEL SHIMS
- WAY SEE DETAIL
- (6) TURNED DOWN CONG. \$LAB W 10° CONTINUOUS POURED CONCRETE FOUNDATION WALL MIN 2'-6" BELOW GRADE SEE PORCH SECTION
- 1) SHELF FOR JOIST BEARING SEE SECTION
- 8 SUMP PIT 4 PUMP W MIN IS "\$XIS" DEEP W FITTED COVER W BATTERT BACKUP VERPT SUMP LOCATION W CUNER PROVIDE 4" PERFORATED DRAN & BASE OF FOOTING IN I" CLEAN CRUSHED STONE FOR ENTIRE PERIMETER OF BASEMENT.
- 9 FLOOR DRAIN SLOPE FLOOR 1/4"/FT. TO DRAIN VERIFY
- POURED IN PLACE CONCRETE STAIR MIN 10" TREADS & MAX
- (II) DEFRESS FOUNDATION . GARAGE DOOR & MAN DOOR
- (3) FURNACE / A/C UNITS COORDINATE W/ HYAC CONTRACTOR
- (4) WATER HEATER
- (15) MIN 200 AMP (599 AMPS MAX) ELECTRIC PANEL
- (6) CODE APPROVED EMERGENCY EGRESS WINDOW MAX SILL 44" AFF. MIN 20" CLEAR OPENING WIDTH MIN 24" CLEAR OPENING HEIGHT MIN 5.1 50. FT. NET CLEAR OPENING OBTAINED BY NORMAL OPERATION OF THE WINDOW FROM THE INSIDE
- (18) PROVIDE NEW SEWER LINE TO MAIN . STREET

- (24) FOUR (4) P.T. 2x12 STRINGERS EQUALLY SPACED
- (25) 113" 360's TJI's . 16" O.C.
- 26) PROVIDE ROUGH IN FOR BATH SEE SHEET A-2
- 27) FIFTH STRINGER (PT. 2x12) FROM BASE OF STAIR TO WALL
- 28) PROVIDE CONDUIT FOR OWNER SELECTED LANDSCAPE

BASEMENT PLAN KEYED NOTES:

- () CONTINUOUS POURED CONCRETE FOUNDATION WALL W/ CONT. POURED CONCRETE FOOTING MIN. 2'-6" BELOW GRADE - SEE PLAN FOR SIZE
- 2) 4° TK. CONCRETE SLAB W 6% W.4%W.4 WLF OVER 10 MIL VAPOR BARRIER 4 4" COMPACTED GRANULAR FILL PROVIDE CRACK CONTROL JOINTS 6 10"-6" MAX. OC. EA WAY. TOOLED CONTROL JOINTS 6 DRIVE 4 PATIOS (I.T. BROOM FINISH). ZIP STRIPS 6 BASEMENT 4 GARAGE SLABS (MAG FINISH). SLOPE GARAGE SLAB TO OVERHEAD DOOR LOCATIONS - MIN #" / FT -SLOPE DRIVEWAY SLAB MIN !" / FT AWAY FROM HOUSE

- 3" DIA x 158 LB/FT. (SCHEDULE 40) FIXED, NON-ADJUSTABLE STL. PIPE COL. (UHERE OCCURS SEE PLAN FOR DIAMETER) ON 3'-Ø" x 3'-Ø" x 12" TK. (MIN) CONC. PAD W/ 4'6 4 8" O.C. EACH
- CONNECT TO SUMP
- LOCATION W/ OWNER

- (12) 14" SQUARE OR 16" CONCRETE PIER MIN 30" BELOW GRADE

- 1) EMERGENCY EGRESS ESCAPE WELL BY BOUMAN KEMP OR EQUAL SEE DETAIL
- (9) PROVIDE OPTION FOR NEW INDERGROUND ELECTRIC SERVICE, MIN 200 AMPS, NEW PANEL & CIRCUIT BREAKERS IN LIEU OF NEW SERVICE DROP FROM POLE. PANEL LOCATION TO BE COORDINATED BETWEEN ELECTRICIAN & CUNER
- 20 CONNECT TO EXISTING U.G. WATER SERVICE TO STREET MAIN -MIN 14* - COORDINATE METER LOCATION W UTILITY COMPANY & OWNER
- (2) CONNECT TO EXISTING U.G. GAS SERVICE TO STREET COORDINATE METER LOCATION W/ UTILITY COMPANY 4 OWNER
- 22) LINE INDICATES LIMIT OF CONCRETE PATIO ABOVE
- (23) TWO (2) 5 BARS ALL AROUND WINDOW OPENING

Park Station , MO 63119 8-9202

Date:

June 7, 2021

A REVISION (DATE-BY):

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411 West Adams /
Kirkwood, MO 6.

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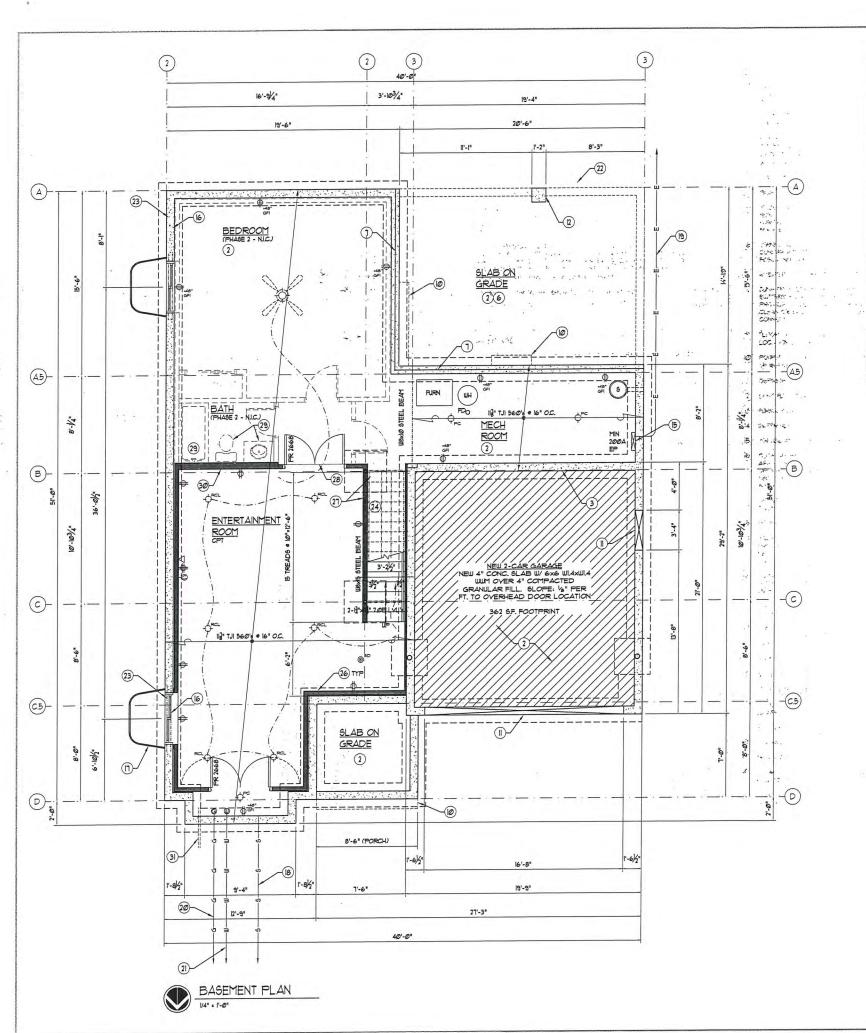
> Drawn By: TS/BE

Checked By:

Drawing Name: Foundation Plan

Sheet No.

A-1



FLOOR PLAN NOTES:

ALL EXTERIOR WALLS 2x4 WOOD STUDS . 16" O.C. W . WOOD STRUCTURAL PANELS ONE SIDE 4 1 GUB ONE SIDE UNLESS OTHERWISE

ALL INTERIOR WALLS 2x4 WOOD STUDS @ 16" O.C. W/ $\frac{1}{3}$ " GWB BOTH SIDES UNLESS OTHERWISE NOTED

PROVIDE DOUBLE JOISTS UNDER WALLS PARALLEL TO JOIST SPANS

PROVIDE SOLID BLOCKING BENEATH GIRDER TRUSS BEARING POINTS TO FOUNDATION OR STEEL BEAM BELOW

ELECTRICAL CONTRACTOR TO COORDINATE FINAL LOCATION 4
QUANTITY OF ALL LIGHTS, FANS, RECEPTACLES, SWITCHES AND FLOOR
RECEPTACLES WITH THE OWNER PRIOR TO SUBMITTING BID.

MECHANICAL CONTRACTOR TO COORDINATE FINAL LOCATION & CLAMITITY OF ALL SUPPLY DUCTS & SIZE OF ANY PENETRATIONS THRU FON MALLS & ROUTING OF SUPPLY/RETURN DUCTS PRIOR TO SUBMITTING BID.

THE INTERIOR AND EXTERIOR WALL CONFIGURATION BRACES THE STRUCTURE IN ACCORDANCE WITH OR EQUIVALENT TO THE CONTINUOUS SHEATHING METHADD WITH CORNER REAMING OF SECTION REGULAL OF THE 2009 SIDTION OF INC. (ALL EXTERIOR WALLS TO BE CONTINUOUSLY SHEATHED WITH 1" WOOD STRUCTURAL PANELS)

DOUBLE FLOOR JOISTS EENEATH PARTITIONS ABOVE

LUMBER NOTE:

ALL STRUCTURAL & FRAMING LUMBER TO BE MIN & GRADE SYP OR BETTER

ALL LYL'S MIN 34" BEARING UNLESS OTHERWISE NOTED

BASEMENT PLAN KEYED NOTES:

- (1) CONTINUOUS POURED CONCRETE FOUNDATION WALL W/ CONT. POURED CONCRETE FOOTING MIN 2"-6" BELOW GRADE SEE PLAN FOR SIZE
- 2 4° TK. CONCRETE SLAB W 6% WAWU4 WUF OVER 10° MIL VAPOR BARRIER & 4" COMPACTED GRANULAR FILL PROVIDE CRACK CONTROL JOINTS 10"-0" MAX OC. EA WAY, TOOLED CONTROL JOINTS DRIVE & PATIOS (LT. BROOM FINISH), ZIP STRIPS BASEMENT & GARAGE SLABS (MAG FINISH) SLOPE GARAGE SLAB TO OVERHEAD DOOR LOCATIONS - MIN &" / FT -SLOPE DRIVEWAY SLAB MIN 1 / FT AWAY FROM HOUSE
- 3 TOP OF FOUNDATION WALL MIN 4" ABOVE GARAGE SLAB
- (4) BEAM POCKET GROUT SOLID LEVEL W STEEL SHIMS
- (5) 3" DIA OR 5" DIA x 156 LB/FT, (SCHEDULE 40) FIXED, NON-ADJUSTABLE STL. PIEF COL, (WHERE OCCURS SEE PLAN FOR DIAPHETER) ON 3'-0" x 3'-0" x "I" K. (MIN) CONC, PAD W/ %'6 0 8" OC. EACH WAY SEE DETAIL
- (6) TURNED DOWN CONC. SLAB W 10" CONTINUOUS POURED CONCRETE FOUNDATION WALL - MIN. 2'-6" BELOW GRADE - SEE
- 1 4" CHELF FOR JOIST BEARING SEE SECTION
- (2.52° FIT 4 PUMP W MIN 15" M36" DEEP W FITTED COVER W BATTERY BACKUP VERRY SUMP LOCATION W CHURE FROVIDE 4"4 PERFORATED DRAIN 4 BASE OF FOOTING IN I' OLEAN CRUSHED STONE FOR ENTIRE FERRICITER OF BASETENT. CONNECT TO SUMP
- 11.00R DRAIN SLOPE FLOOR 1/6"/FT. TO DRAIN VERIFY
- POLICED IN PLACE CONCRETE STAIR MIN 10" TREADS & MAX
- (II) DEFREES FOUNDATION . GARAGE DOOR & MAN DOOR
- (2) CONCESTE PIER MIN 30" BELOU GRADE SEE PLAN FOR SIZE
- (3) RURNACE / A/C UNITS COORDINATE W/ HYAC CONTRACTOR
- (K) WATER HEATER
- MIN 2000 AMP (599 AMPS MAX) ELECTRIC PANEL
- (L) CODE APPROVED EMERGENCY EGRESS WINDOW MAX SILL 44"
 (J.F. MIN. 20" CLEAR OFENING WIDTH MIN. 24" CLEAR
 CYENING HEIGHT MIN. 5.T 50, FT. NET CLEAR OFENING OBTAINED BY NORMAL OPERATION OF THE WINDOW FROM THE
- THE MERGENCY EGRESS ESCAPE WELL BY BOWMAN KEMP OR EQUAL - SEE DETAIL
- (S) PROVIDE NEW SEWER LINE TO MAIN . STREET
- PROVIDE OPTION FOR NEW UNDERSEAUND ELECTRIC SERVICE, MIN. 200 AHPS, NEW PANEL & CIRCUIT BREAKERS IN LIEU OF NEW SERVICE DROP FROM POLE. PANEL LOCATION TO BE COORDINATED BETWEEN ELECTRICIAN & OWNER
- 20 CONNECT TO EXISTING U.G. WATER SERVICE TO STREET MAIN -MIN 13"4 - COORDINATE METER LOCATION W UTILITY COMPANY & CUNER
- (2) CONNECT TO EXISTING U.G. GAS SERVICE TO STREET -COORDINATE METER LOCATION UV UTILITY COMPANY 4 OWNER
- 22) LINE INDICATES LIMIT OF CONCRETE PATIO ABOVE
- (23) TWO (2) 5 BARS ALL AROUND WINDOW OPENING
- (24) FOUR (4) P.T. 2x12 STRINGERS EQUALLY SPACED
- 25) 113° 360's TJI's @ 16" O.C.
- 26 TYPICAL WALL FURRING P.T. 2x4 SILL PLATE, 2x4 WOOD STUDS * 16" O.C., MINIMUM R-10 INSULATION, 6 MIL VAPOR BARRIER 4 3" GYPSUM BOARD - HOLD STUDS 1" OFF FOUNDATION WALL TO ENSURE STRAIGHT, PLUMB WALL SURFACE (PHASE 2 - NIC.)
- 21) 14" # WOOD HANDRAIL # STAIR SEE STAIR DETAILS
- 28 FLCORING CHANGE TRANSITION STRIP
- 29 FROVIDE ROUGH-IN FOR FUTURE BATH
- 30 COORDINATE WALL FRAMING & WIDTH W/ PLUMBING CHASE
- (3) PROVIDE CONDUIT FOR OWNER SELECTED LANDSCAPE LIGHTING



Park Station MO 63119 -9202

Date:

June 7, 2021

A REVISION (DATE-BY):

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Homebuye
411 West Adams /
Kirkwood, MO 6.

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MICHAE
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BLAES
NUMBER
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Mighaele Blaes - Architect
A-6158
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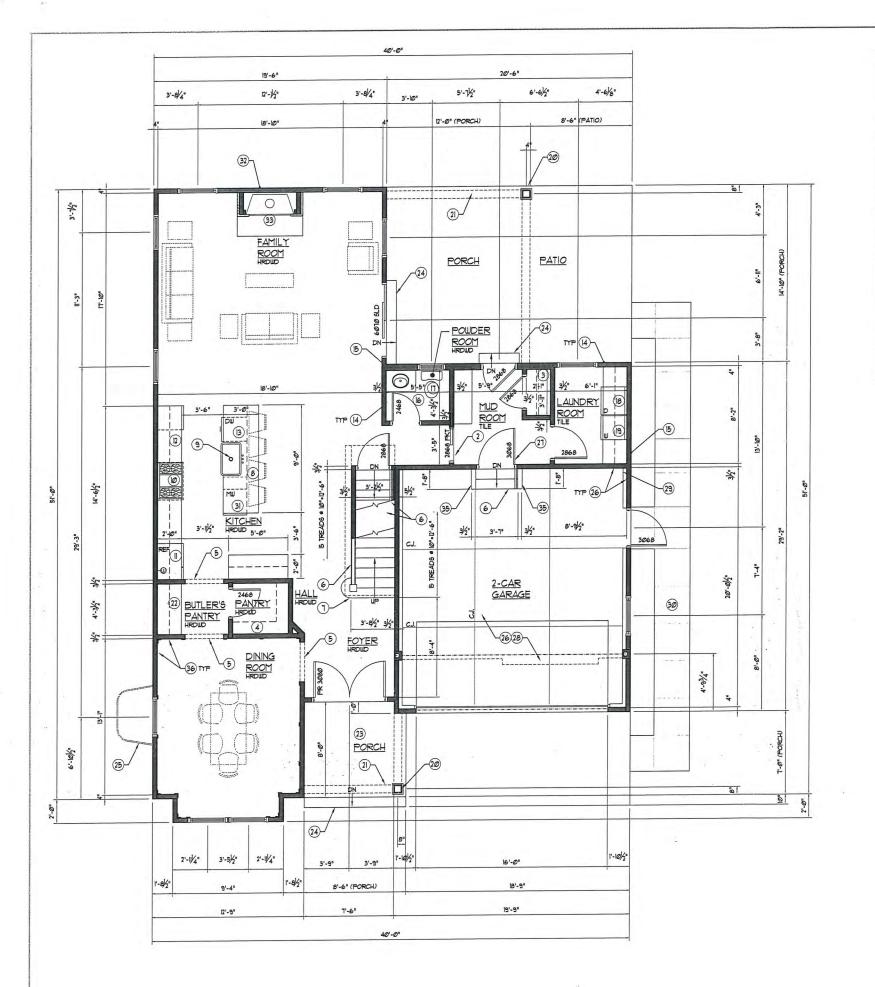
> Drawn By: TS/BE

Checked By:

Drawing Name: Basement Plan

Sheet No.

A-2



FLOOR PLAN NOTES:

ALL EXTERIOR WALLS 2x4 WOOD STUDS . I6" O.C. W/ 1" WOOD STRUCTURAL PANELS ONE SIDE 4 1" GUB ONE SIDE UNLESS OTHERWISE

PROVIDE DOUBLE JOISTS UNDER WALLS PARALLEL TO JOIST SPANS

PROVIDE SOLID BLOCKING BENEATH GIRDER TRUSS BEARING POINTS TO FOUNDATION OR STEEL BEAM BELOW

ELECTRICAL CONTRACTOR TO COORDINATE FINAL LOCATION 4
QUANTITY OF ALL LIGHTS, FANS, RECEPTACLES, SUITCHES AND FLOOR
RECEPTACLES WITH THE OWNER PRIOR TO SUBMITTING BID.

MECHANICAL CONTRACTOR TO COORDINATE FINAL LOCATION 4 QUANTITY OF ALL SUPPLY DUCTS 4 SIZE OF ANY PENETRATIONS THRU FON WALLS 4 ROUTING OF SUPPLY/RETURN DUCTS PRIOR TO SUBMITTING BID.

SHEATHED WITH 1" WOOD STRUCTURAL PANELS)

DOUBLE FLOOR JOISTS BENEATH PARTITIONS ABOVE

LUMBER NOTE:

ALL INTERIOR WALLS 2x4 WOOD STUDS @ 16" O.C. W/ 1/2" GUB BOTH SIDES WILESS OTHERWISE NOTED

THE INTERIOR AND EXTERIOR WALL CONFIGURATION BRACES THE STRUCTURE IN ACCORDANCE WITH OR EQUIVALENT TO THE CONTINUOUS SHEATHING METHOD WITH CORNER FRAMING OF SECTION REGIZED ALO THE 2009 EDITION OF IRC. (ALL EXTERIOR WALLS TO BE CONTINUOUSLY

ALL STRUCTURAL 4 FRAMING LUMBER TO BE MIN 9 GRADE SYP OR BETTER

ALL LVL'S MIN 3 BEARING UNLESS OTHERWISE NOTED

FIRST FLOOR KEYED NOTES:

- PROVIDE SOLID BLOCKING ALL BEARING POINTS TO STEEL OR CONC. STRUCTURE BELOW
- 2) FLOORING CHANGE TRANSITION STRIP
- 3 SHELF & CENTERPOLE
- 4 MIN FOUR (4) ADJUSTABLE SHELVES
- 5 CASED OPENING
- 6 14" WOOD HANDRAIL & STAIR SEE STAIR DETAILS
- MIN 69" SQUARE NEWEL POST COORDINATE SELECTION WOUNER
- (8) ISLAND III/ BASE CABINETS SEE KITCHEN DESIGNER'S PLANS FOR FINAL SIZE & LOCATION
- (9) GARBAGE DISPOSAL W WALL SWITCH
- OVEN/RANGE W HOOD 4 LIGHTS VENT DIRECTLY TO EXTERIOR SEE KITCHEN DESIGNER'S PLAN
- (I) REFRIGERATOR W WATER VALVE IN WALL FOR ICEMAKER
- (2) COUNTERTOP W OWNER SELECTED TILE BACKSPLASH EXTEND TO WALL CABINETS SEE KITCHEN DES. PLAN
- (13) 24" DISHWASHER COORDINATE SELECTION W OWNER
- PROVIDE MR GYP BD # ALL BATH # LAINDRY ROOM WALLS # CEILING FULL HEIGHT
- (5) COORDINATE WALL FRAMING & WIDTH W PLUMBING CHASE REQUIREMENTS
- (6) VANITY COORDINATE SELECTION W CONTRACTOR
- 1) TOILET MIN 21" CLEAR IN FRONT OF FIXTURE PER IRC
- 18 VENT DRYER TO EXTERIOR
- (9) PROVIDE ALL-IN-ONE WASHER PLUMBING BOX W WASTE 4 H/C WATER SUPPLIES RECESSED IN STUD WALL PROVIDE DRAIN PAN BENEATH WASHER (OR FLOOR DRAIN)
- 8" SQUARE LOAD BEARING PERMACAST COLUMN IIV CAP 4 BASE BY HB4G OR APPROVED EQUAL
- (21) PROFILE OF BOX BEAM ABOVE SEE PORCH SECTION
- 22) BUTLER'S PANTRY CABINETRY COORDINATE SELECTION W/
- 23 POURED IN PLACE CONCRETE PORCH / PATIO SLAB COORDINATE FINAL SLAB COLOR & FINISH W OWNER SLOPE AUJAY FROM HOUSE MIN 1"/FT
- (24) POURED IN PLACE CONCRETE STAIR MIN 10" TREADS, MAX 13" RISERS SEE SECTION
- 25 EMERGENCY EGRESS WINDOW WELL
- (26) PROVIDE §" GYP BD . ALL GARAGE WALLS 4 §" TYPE 'X' GYP BD. . GARAGE CEILING
- 27 29 MINUTE FIRE DOOR OR 13" SOLID CORE WOOD DOOR OR MINUMUM 13," SOLID OR HONEYCOMB CORE STEEL DOOR
- 28 4" CONC. SLAB W 6x6 WL4xWL4 WUM OVER 10 MIL VAPOR BARRIER OVER 4" COMPACTED GRANULAR FILL. SLOPE 1/8"
 PER FT. (MIN) TO OVER-JEAD DOOR LOCATIONS - PROVIDE ZIP
 STRIP CONTROL JOINTS 6 10"-0" O.C. EA/ WAY - MAG FINISH
- 29 TOP OF FOUNDATION WALL MIN 4" ABOVE GARAGE SLAB
- 30 4" CONC. WALK W/ 6X6 WI.4XWI.4 WWF OVER 4" COMPACTED GRANULAR FILL - PROVIDE TOOLED CONTROL JOINTS . 5'-0" O.C. MAX. (LT. BROOM FINISH)
- 3) BUILT-IN MICROWAVE OR MICROWAVE DRAWER COORDINATE
- 32) DIRECT VENT GAS FIREPLACE UNIT BY HEAT-N-GLO OR EQUAL INSTALL PER MANUFACTURER'S SPECIFICATIONS MINIMUM 18" NON-COMBUSTABLE HEARTH READILY DISTINGUISHED FROM SURROUNDING FLOOR AREA
- (35) HALF WALL W/ IX CAP MIN 36" ABOVE STAIR NOSING -PROVIDE 14" # WOOD HANDRAIL - SEE DETAIL
- (36) 54" CROWN MOLDING . PERIMETER OF DINING ROOM
- (37) OUNER SELECTED MICROUAVE DRAWER INSTALL PER MANUFACTURER'S SPECIFICATIONS



Date: June 7, 2021

A REVISION (DATE-BY):

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Avenue 63122 Adams Adams od, MO 6 11 West Ad
 Kirkwood,

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OF MISSO MICHAEL **EDWARD** BLAES

NUMBER

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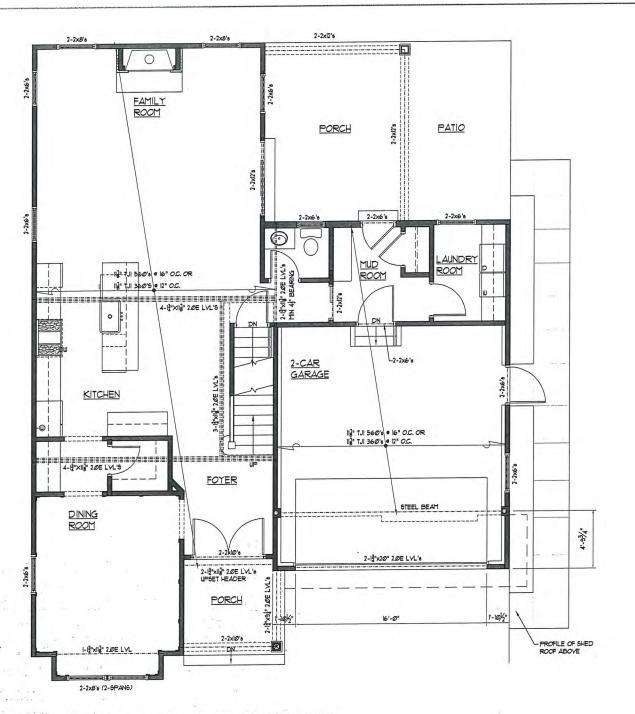
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First Floor Plan

Sheet No.

A-3



FIRST FLOOR PLAN (W/ SECOND FLOOR FRAMING)

FLOOR PLAN NOTES:

ALL EXTERIOR WALLS 2x4 WOOD STUDS . 16" O.C. W/ 1" WOOD STRUCTURAL PANELS ONE SIDE 4 J. GUB ONE SIDE UNLESS OTHERWISE NOTED

ALL INTERIOR WALLS 2x4 WOOD STUDS @ 16" O.C. W/ 1 2" GWB BOTH SIDES UNLESS OTHERWISE NOTED

PROVIDE DOUBLE JOISTS UNDER WALLS PARALLEL TO JOIST SPANS


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MECHANICAL CONTRACTOR TO COORDINATE FINAL LOCATION 4
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DOUBLE FLOOR JOISTS BENEATH PARTITIONS ABOVE



STAIR / BUILDING SECTION A-4 SCALE: V4" = 1'-0" (SPINDLES OMITTED FOR CLARITY)

Sheet No.

Date: June 7, 2021 A REVISION (DATE-BY):

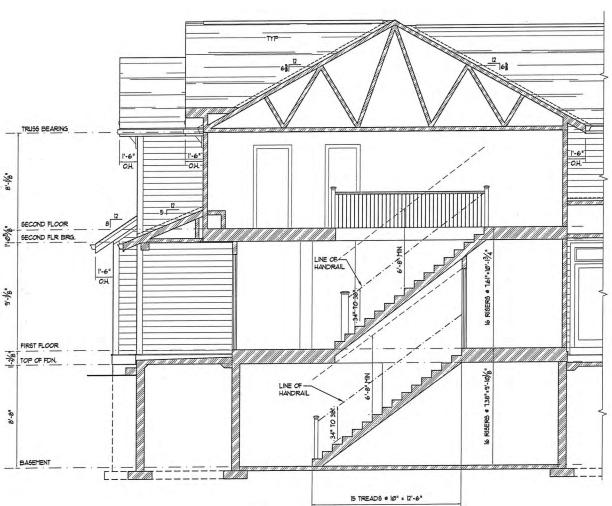for: S Avenue 63122 Homebuyers, 0 411 West Adams Kirkwood, MO <u>S</u> 0 ≥ © Z STL

OF MISSOURI W. ** MICHAEL **EDWARD** BLAES NUMBER

Michael Billies Architect
MO # A-6158*

A 6-6158*
MO # A-6158*
A 6-6158*
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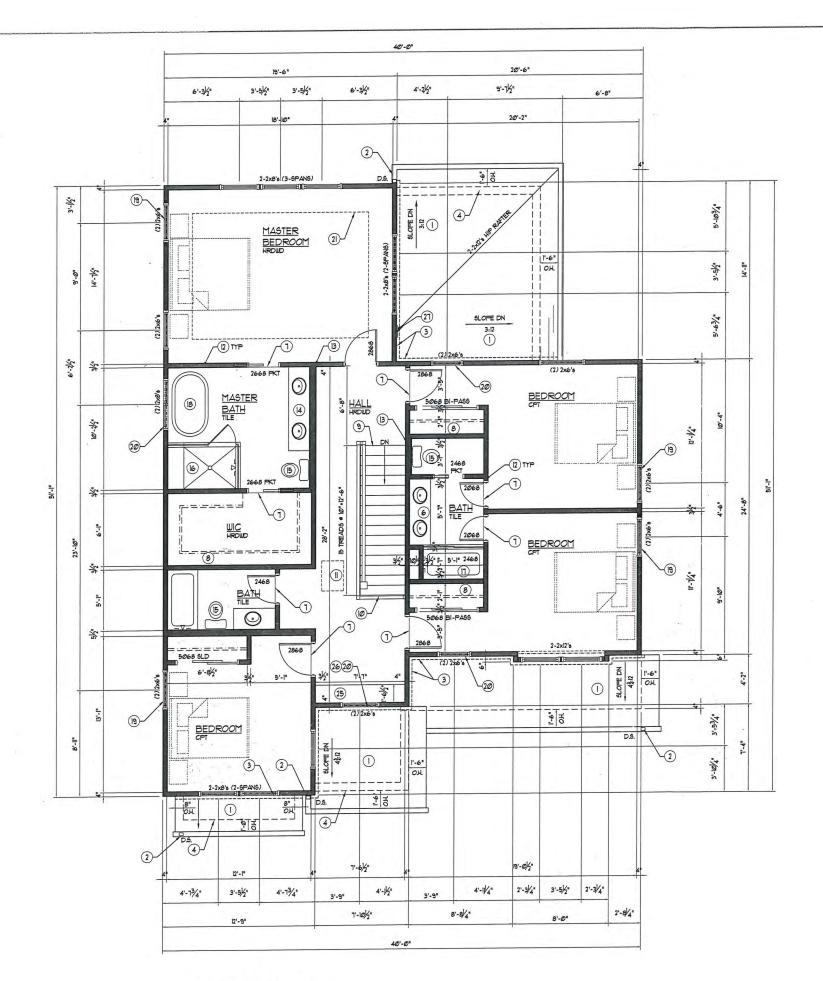
Drawn By: TS/BE Checked By:

Drawing Name: Framing Plan, Stair Section

A-4

LUMBER NOTE:

ALL STRUCTURAL & FRAMING LUMBER TO BE MIN & GRADE SYP OR BETTER ALL LVL'S MIN. 3/" BEARING UNLESS OTHERWISE NOTED





SECOND FLOOR / ROOF PLAN KEYED NOTES:

- ASPHALT SHINGLES ON 15° ROOFING FELT 4 1/2" STRUCTURAL WOOD PANELS
- 2 5" ALLMINUM GUTTER 4 3x4 D.S. PROVIDE LEAF GUARDS
- 3 CONTINUOUS ALUMINUM FLASHING INTERLACE SHINGLES @ ROOF VALLEYS UV ICE 4 WATHER SHIELD BELOW
- 4 PROFILE OF STRUCTURE BELOW
- 5 PROFILE OF WOOD BRACKET BELOW
- 6 5'-@" DOUBLE VANITY COORDINATE SELECTION W CONTRACTOR
- 1) FLOORING CHANGE TRANSITION STRIP
- 8 SHELF 4 CENTERPOLE
- 9 14 1000 HANDRAIL 4 STAIR SEE STAIR DETAILS
- (ID) WOOD GUARDRAIL 4 NEWEL POST SEE DETAIL
- II) MIN 22"x30" CODE REQUIRED ATTIC ACCESS HATCH
- (2) PROVIDE MR GYP BD # ALL BATH WALLS # CEILING FULL HEIGHT
- B COORDINATE WALL FRAMING & WIDTH W PLUMBING CHASE REQUIREMENTS
- (4) T'-0" VANITY COORDINATE SELECTION W CONTRACTOR
- (5) TOILET COORDINATE SELECTION W CONTRACTOR
- (6) CUSTOM SHOWER PAN & ENCLOSURE W/ TYPE II TEMPERED GLASS SHOWER ENCLOSURE
- (1) 5'-0" TUB/SHOWER COMBO UNIT COORDINATE SELECTION W/ OWNER
- (18) OWNER SELECTED FREE STANDING TUB
- (9) CODE APPROVED EMERGENCY EGRESS WINDOW MAX SILL 44" AFF. MIN 20" CLEAR OPENING WIDTH MIN 24" CLEAR OPENING HEIGHT MIN 5.1 SQ FI NET CLEAR OPENING CETAINED BY NORMAL OPERATION OF THE WINDOW FROM THE
- PROVIDE TEMPERED GLASS # WINDOWS ADJACENT TO DOOR SWINGS # HAZARDOUS LOCATIONS
- (21) PROFILE OF TRAY CEILING ABOVE
- 22) MIN FOUR (4) ADJUSTABLE SHELVES
- (23) 2% RAFTERS 2% CEILING JOISTS 24* O.C. W 2-2½12'6 HIP RAFTERS OR PRE-ENGINEERED CODE APPROVED TRUSGES 24* O.C.
- 24 23" TK WALL: 2x4 STUDS (FLAT) . 16" O.C. W 3" GYP BD EA SIDE
- 25 18" HIGH AFF, BUILT IN BENCH SEAT COORDINATE W/ OWNER
- PROVIDE TEMPERED GLASS & CODE REQUIRED FALL PROTECTION DEVICE WINDOW ABOVE BENCH SEAT
- 27) FACE MOUNT HANGER: SIMPSON HUZIØ-2X SKL455LDIØ
- 28) 3'-6" YANITY COORDINATE SELECTION W/ CONTRACTOR
- 29 3'-0" x 5'-0" SHOWER PAN W TEMPERED GLASS SHOWER DOOR

FLOOR PLAN NOTES:

ALL EXTERIOR WALLS 2x4 WOOD STUDS . IG . O.C. W 1 WOOD STRUCTURAL PANELS ONE SIDE 4 3" GUB ONE SIDE UNLESS OTHERWISE

ALL INTERIOR WALLS 2x4 WOOD STUDS # 16" O.C. W/ V_2 " GWB BOTH SIDES UNLESS OTHERWISE NOTED

PROVIDE DOUBLE JOISTS UNDER WALLS PARALLEL TO JOIST SPANS

PROVIDE SOLID BLOCKING BENEATH GIRDER TRUSS BEARING POINTS TO FOUNDATION OR STEEL BEAM BELOW

ELECTRICAL CONTRACTOR TO COORDINATE FINAL LOCATION 4 QUANTITY OF ALL LIGHTS, FANS, RECEPTACLES, SWITCHES AND FLOOR RECEPTACLES WITH THE OWNER PRIOR TO SUBMITTING BID.

MECHANICAL CONTRACTOR TO COORDINATE FINAL LOCATION 4 CHANTITY OF ALL SUPPLY DUCTS 4 SIZE OF ANY FENERATIONS THRU FON WALLS 4 ROUTING OF SUPPLY/RETURN DUCTS PRIOR TO SUBMITTING BID.

THE INTERIOR AND EXTERIOR WALL CONFIGURATION BRACES THE STRUCTURE IN ACCORDANCE WITH OR EQUIVALENT TO THE CONTINUOUS SHEATHING METHOD WITH CORNER FRAMING OF SECTION REGIZED ALOF THE 2009 SETTION OF IRC. (ALL EXTERIOR WALLS TO BE CONTINUOUSLY SHEATHED WITH !" WOOD STRUCTURAL PANELS)

LUMBER NOTE:

ALL STRUCTURAL 4 FRAMING LUMBER TO BE MIN 9 GRADE SYP OR BETTER



Date: June 7, 2021

A REVISION (DATE-BY):

CO

Homebuyers, 411 West Adams Avenue Kirkwood, MO 63122 411 West Adams Kirkwood, MO 6

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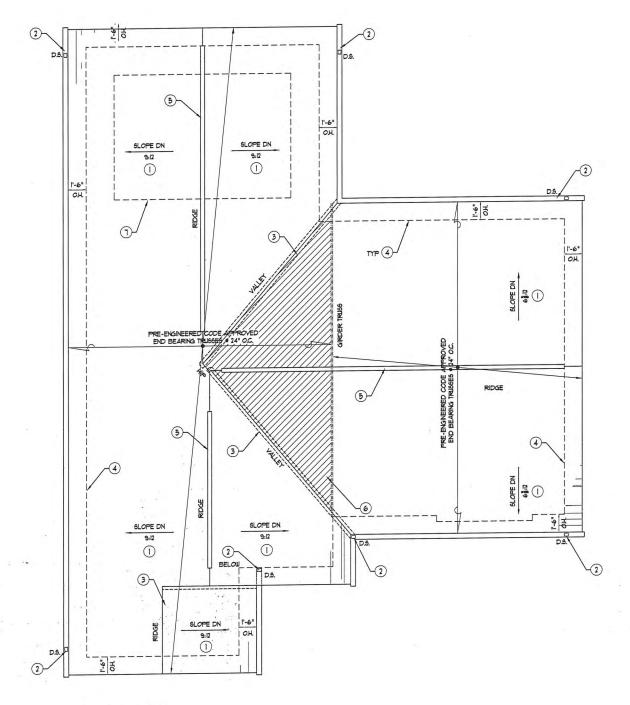
> Drawn By: TS/BE

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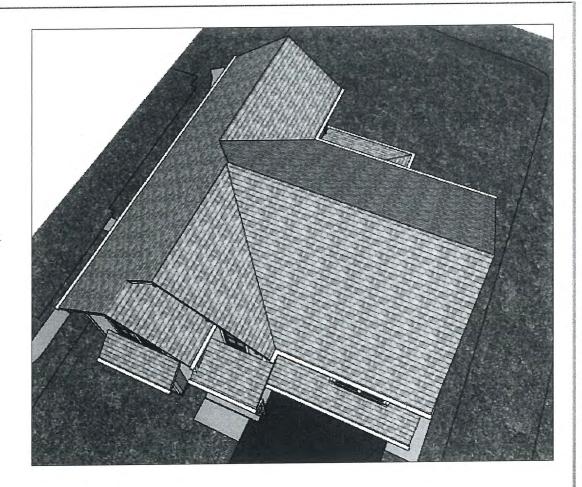
Drawing Name: Second Floor Plan

Sheet No.

A-5







ROOF RENDERING ROOF SCALE: NTS.

FLOOR PLAN NOTES:

ALL EXTERIOR WALLS 2x4 WOOD STUDS . IG " O.C. W/ }" WOOD STRUCTURAL PANELS ONE SIDE 4]" GUB ONE SIDE UNLESS OTHERWISE

ALL INTERIOR WALLS 2x4 WOOD STUDS @ 16" O.C. W/ $\frac{1}{2}$ " GWB BOTH SIDES UNLESS OTHERWISE NOTED

PROVIDE DOUBLE JOISTS UNDER WALLS PARALLEL TO JOIST SPANS

PROVIDE SOLID BLOCKING BENEATH GIRDER TRUSS BEARING POINTS TO FOUNDATION OR STEEL BEAM BELOW

ELECTRICAL CONTRACTOR TO COORDINATE FINAL LOCATION & QUANTITY OF ALL LIGHTS, FANS, RECEPTACLES, SUITCHES AND FLOOR RECEPTACLES WITH THE OWNER PRIOR TO SUBMITTING BID.

MECHANICAL CONTRACTOR TO COORDINATE FINAL LOCATION 4
CUANTITY OF ALL SUPPLY DUCTS 4 SIZE OF ANY PENETRATIONS THRU
FON WALLS 4 ROUTING OF SUPPLY/RETURN DUCTS PRIOR TO SUBMITTING
BID.

THE INTERIOR AND EXTERIOR WALL CONFIGURATION BRACES THE STRUCTURE IN ACCORDANCE WITH OR EQUIVALENT TO THE CONTINUOUS SHEATHING HETHOO WITH COPRIER FRANKS OF SECTION REPOILS.41 OF THE 200'S EDITION OF IRC. (ALL EXTERIOR WALLS TO BE CONTINUOUSLY SHEATHED WITH !" WOOD STRUCTURAL PANELS)

ROOF PLAN KEYED NOTES:

- ASPHALT SHINGLES ON 15° ROOFING FELT 4 1/2" STRUCTURAL WOOD PANELS
- 2 5" ALUMINUM GUTTER 4 3x4 D.5. PROVIDE LEAF GUARDS
- (3) CONTINUOUS ALUMINUM FLASHING INTERLACE SHINGLES ROOF VALLEYS W/ ICE 4 WATHER SHIELD BELOW
- (4) PROFILE OF STRUCTURE BELOW
- 5 CONTINUOUS RIDGE VENT
- 6 HATCHING INDICATES AREA OF 2x OVERFRAMING.
- PROFILE OF TRAY CEILING BELOW SEE SECOND FLOOR PLAN 4 ELEVATIONS
- 8 STANDING SEAM METAL ROOF INSTALL PER MANUFACTURER'S SPECIFICATIONS

LUMBER NOTE:

ALL STRUCTURAL & FRAMING LUMBER TO BE MIN 9 GRADE SYP OR BETTER

ROOF NOTE:

SEE SECOND FLOOR / ROOF PLAN ON SHEET A-5 FOR BALANCE OF PORCH & BAY ROOF NOTES & DIMENSIONS



for:

Homebuyers, 411 West Adams Avenue Kirkwood, MO 63122

Residenc STL 0 WILLIAM OF MISSON OF MISSO

> MICHAEL EDWARD BLAES

> NUMBER

Michael E Blaes - Aprillact


Michael E Blaes


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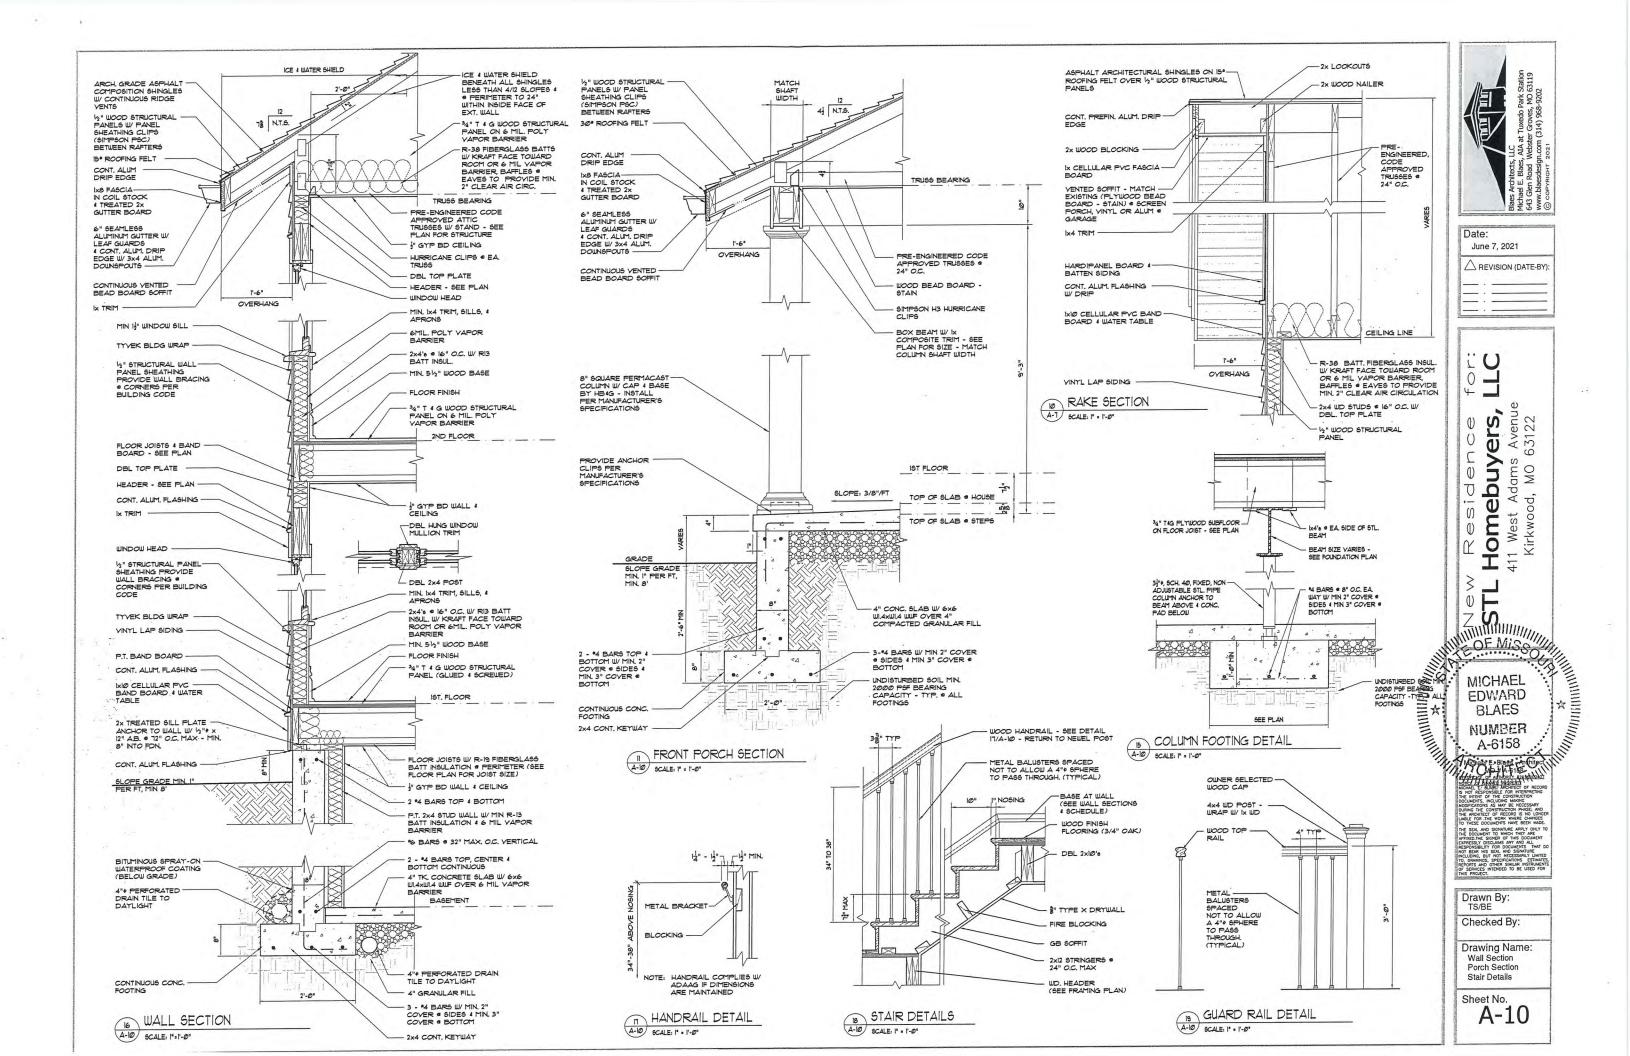
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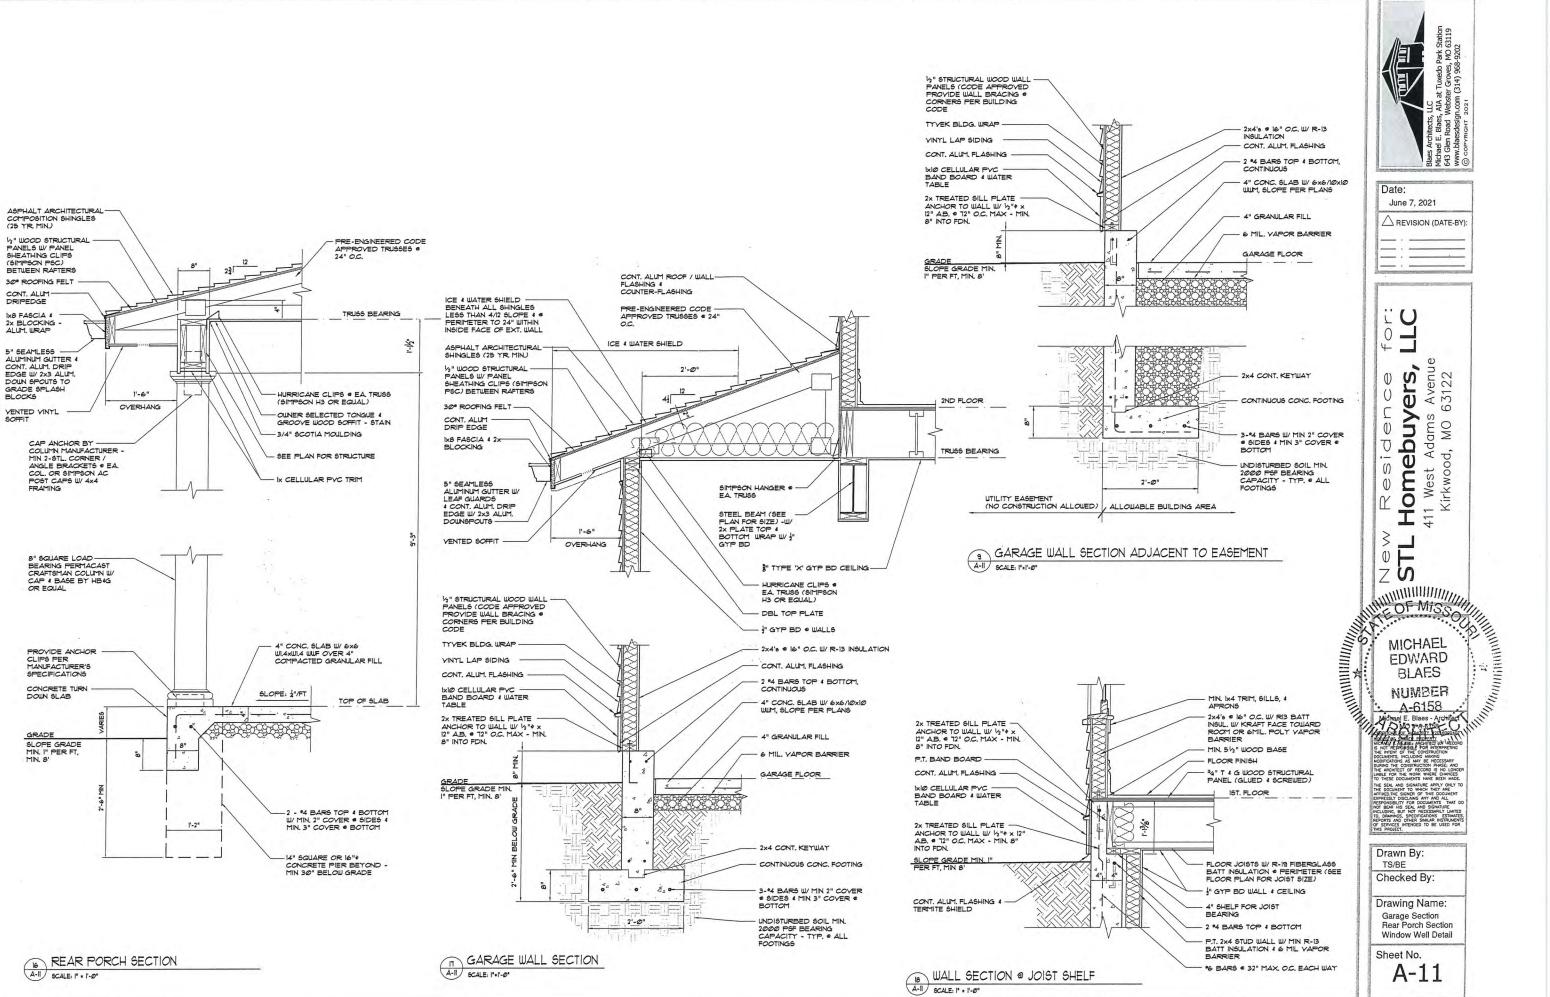
Drawing Name: Roof Plan

Sheet No. A-6





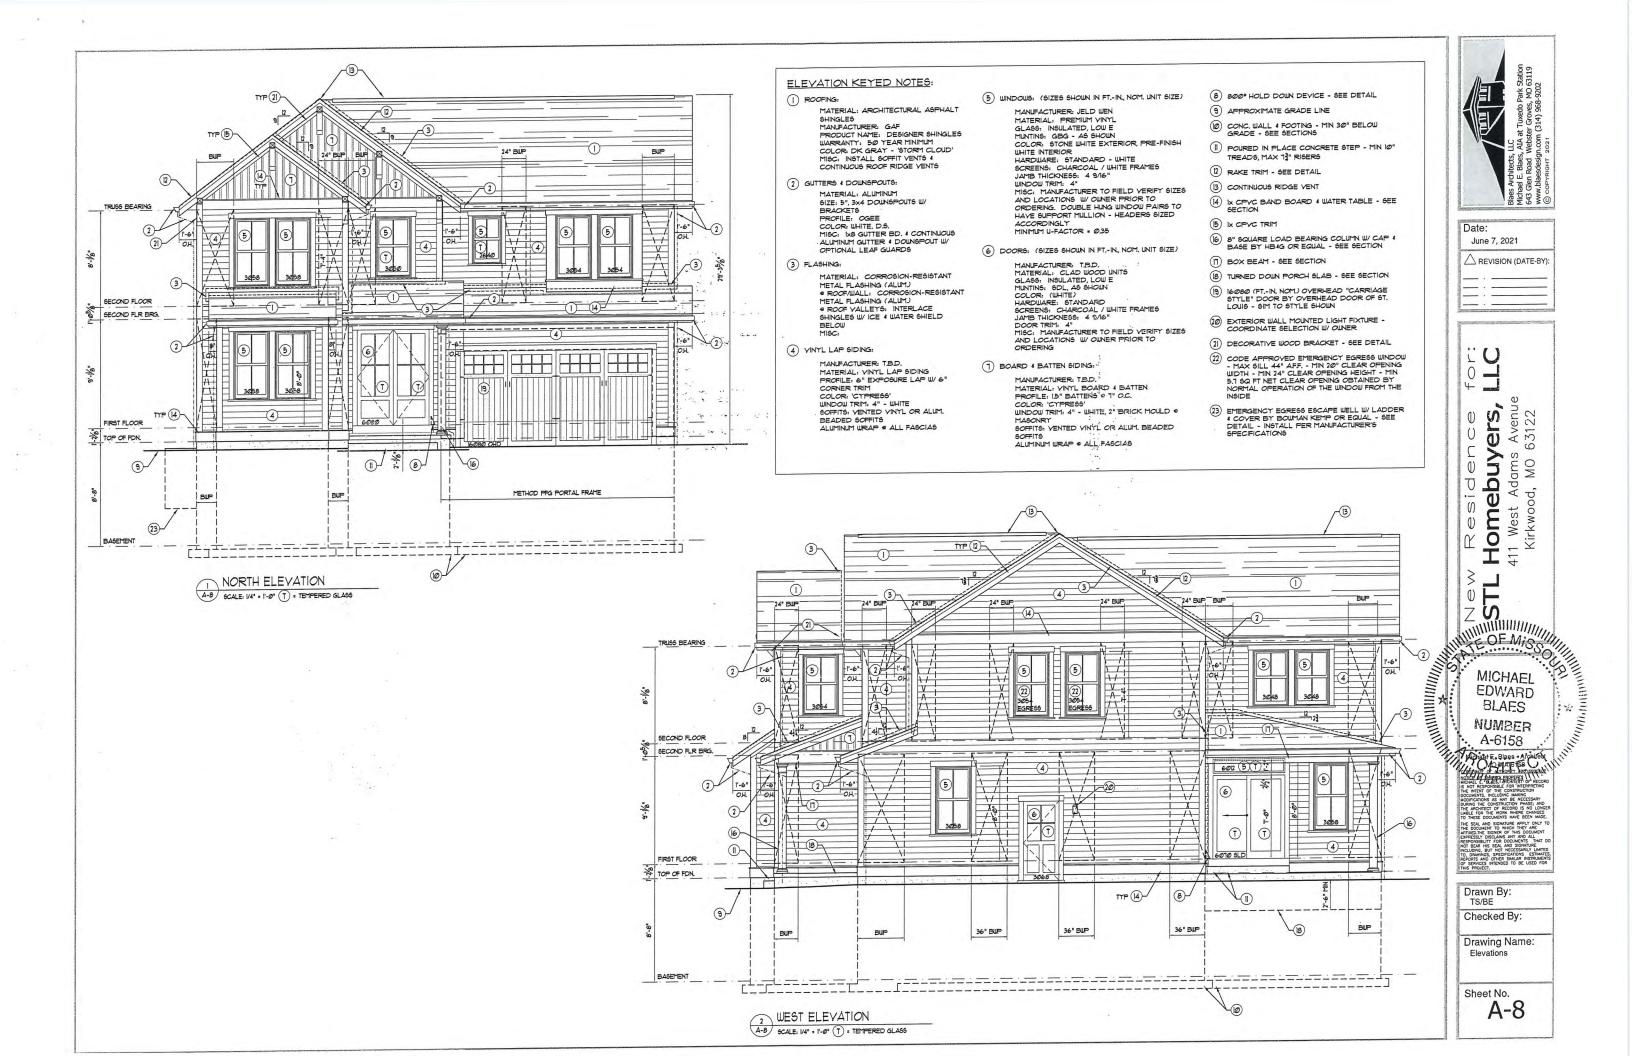

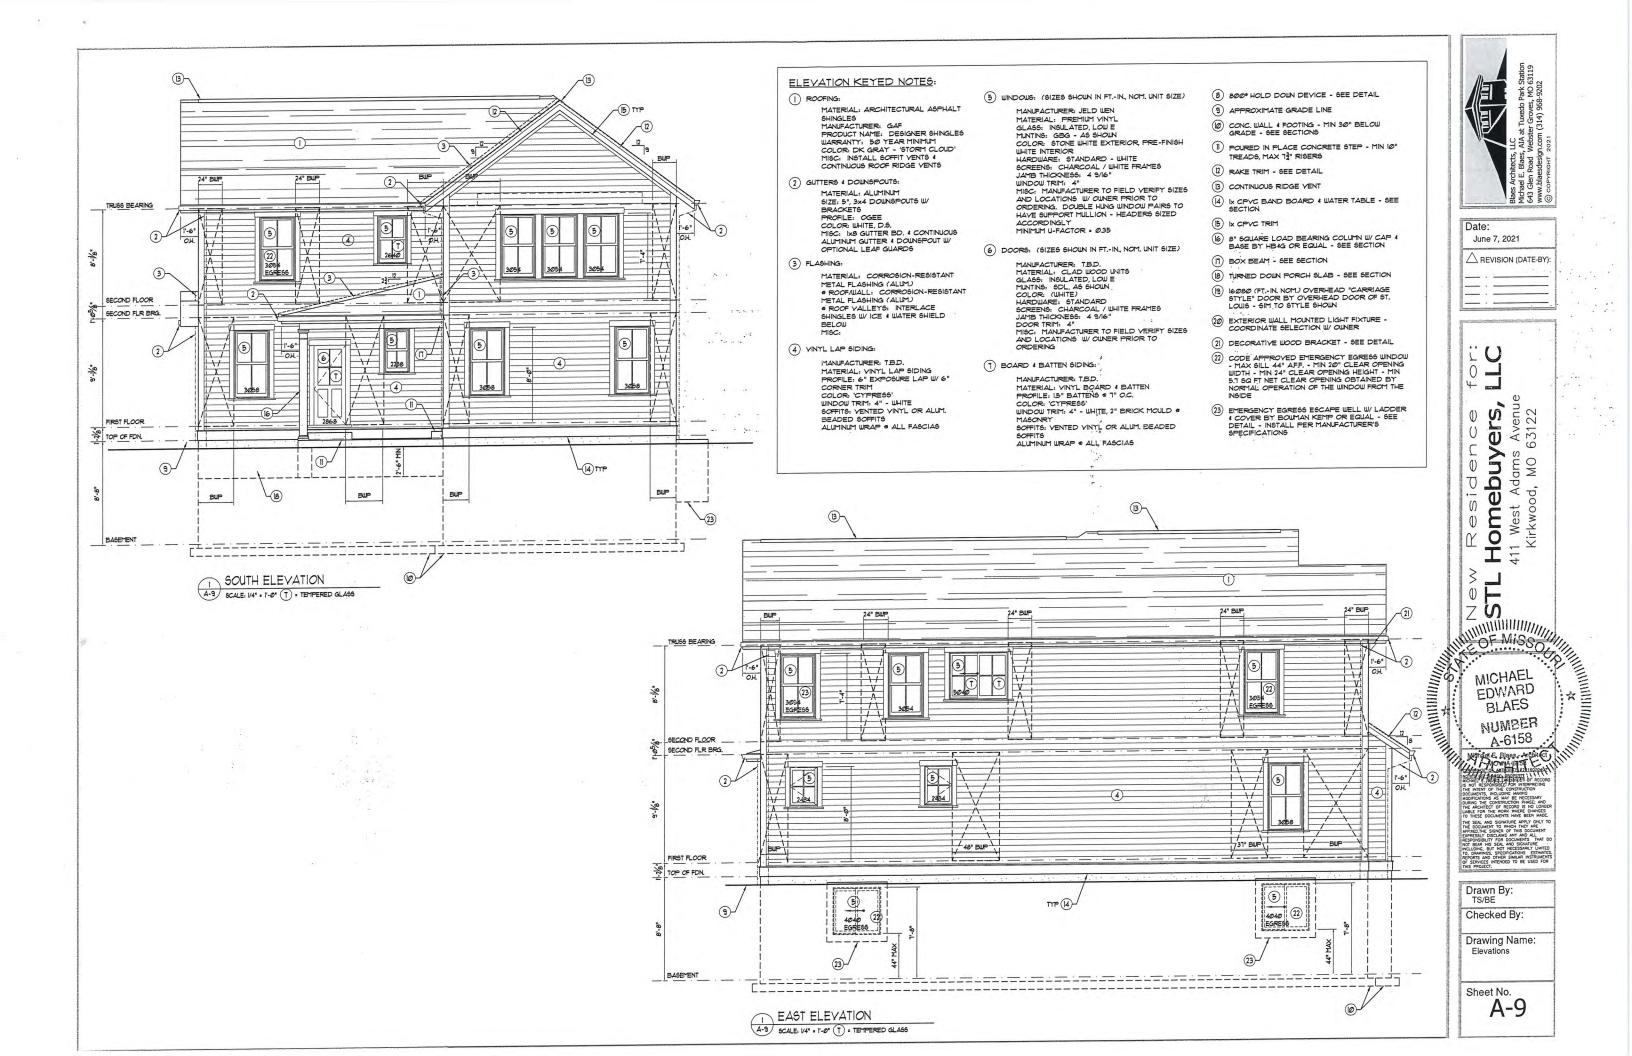

Park Station MO 63119 -9202

June 7, 2021 A REVISION (DATE-BY):

> Avenue 63122 S ē buy Adams d, MO Kirkwood, U West HO

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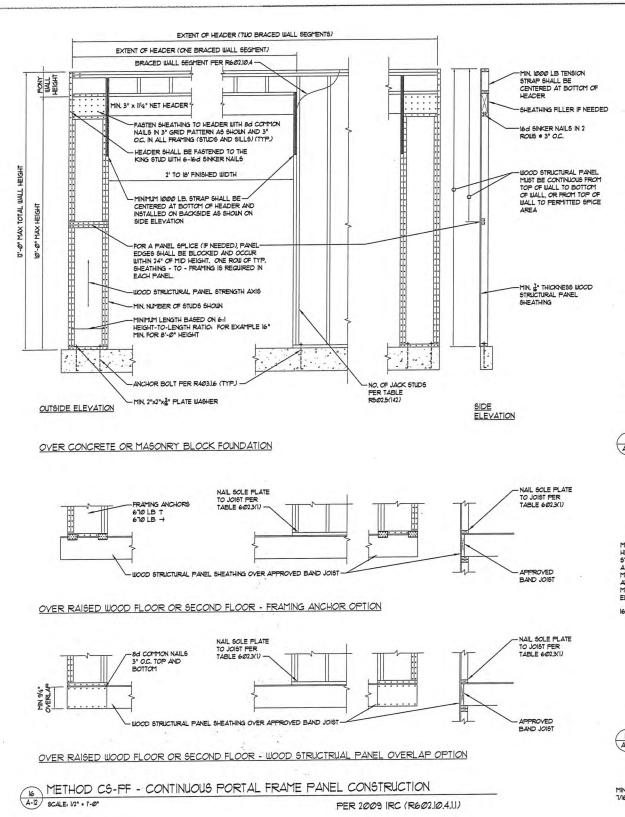
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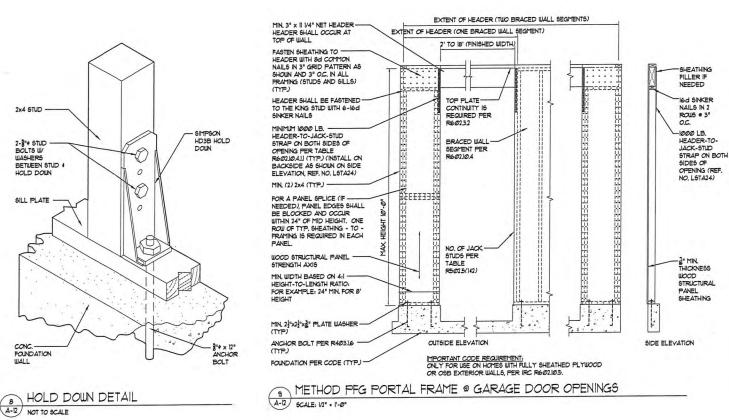
Checked By:

Drawing Name: Garage Section Rear Porch Section Window Well Detail

Sheet No.

A-11





Park Station MO 63119 -9202

Date:

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June 7, 2021

A REVISION (DATE-BY):

Avenue 63122

omebuye West Adams

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ERRIPICATE OF AUTHORITY J2016002407

NOTICE OF SHARED PROPERTY

MICHAEL E BLACK ARCHITECTOR RECORD

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DOCUMENTS, INCLUDING MARKING

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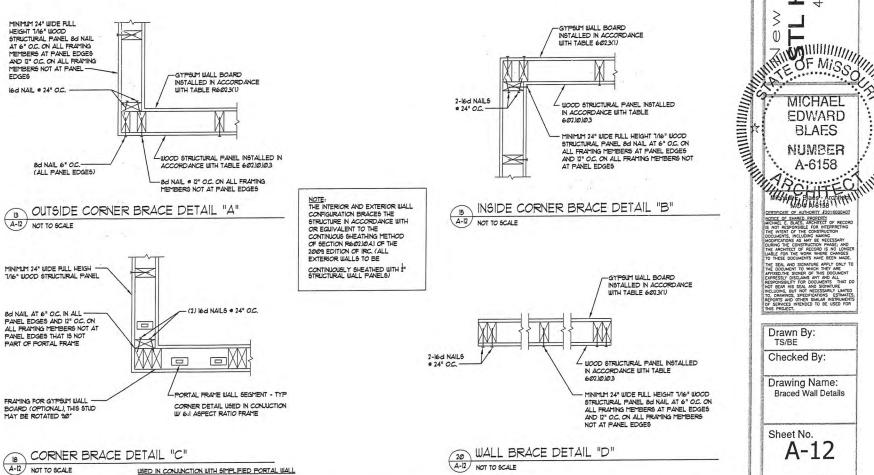
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Drawn By:

Checked By:

Sheet No. A-12

Drawing Name: Braced Wall Details



USED IN CONJUNCTION WITH SIMPLIFIED PORTAL WALL

NOT TO SCALE



Property Address 555 N. Clay

ARCHITE AL REVIEW BOARD DESIGN SUBMISSION APPLICATION

139 S. Kirkwood Rd. Kirkwood, MO 63122 (314) 822-5816 Fax (314) 822-5898

The deadline to submit your application is 2 p.m. one week prior to the meeting date.

See checklist for required submittal documents to accompany this application #22-9




Meetings are held on the 1st and 3rd Mondays (excluding holidays) every month.

Is the property a Kirkwood Landmark? Yes No In a Local Historic District? Scope of work - Coach House contracted to build an 24'x30' detached garage. Construction Type/Fee: New House - \$150.00 Addition - \$100.00 Accessory Structure/All others - \$100.00 APPLICANT Jim Hotop 314-378-2064 Name Phone 400 Raven La Address City, State, Zip_Florissant, Mo 63031 ihotop@coachhousegarages.com E-mail (Agenda will be e-mailed to applicant) PROPERTY OWNER Kyle Moylan Phone_ 314-369-9925 Name 555 N. Clay Ave Address City, State, Zip_ Kirkwood, Mo 63122 ARCHITECT INFORMATION Name Kreher Engineering (618) 281-8505 Phone_ Address 208 N Main St Suite H City, State, Zip Columbia, IL 62236 I have read the Architectural Review and Building regulations of the City of Kirkwood. I hereby certify that the project is located on property for which I have the legal right to construct. I hereby affirm the above statements are true and correct and agree to fully comply with the ordinances of Kirkwood. I hereby certify that the owner(s) of record authorizes the proposed work and I have been authorized by the owner(s) to make this application as their agent. Applicants or their representative shall attend all meetings. James Hotop 03/20/2021 Applicant's Signature **Applicant's Printed Name** Date City Use Only Received by____ Agenda Date___ Zoning Comments Driveway work will require separate Building Comments_


555 N. Clay – Site Photos


Owners Home



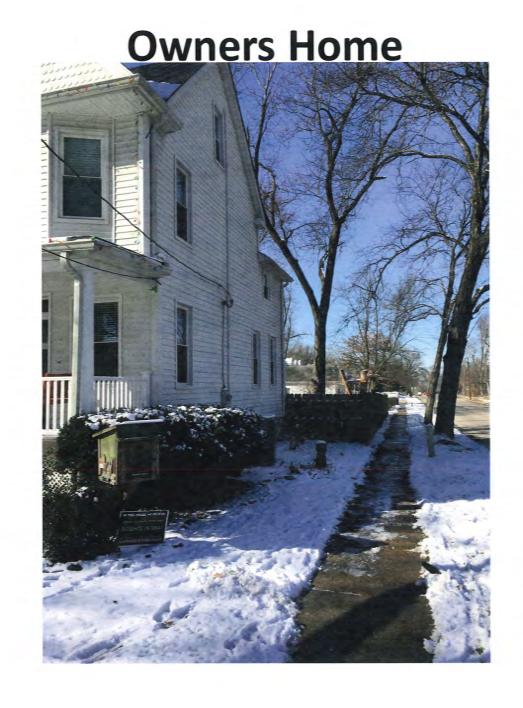


555 N. Clay - Elevations

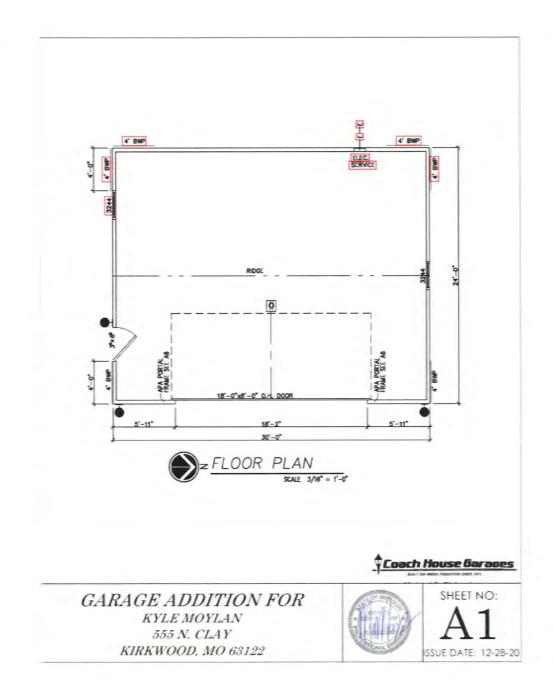

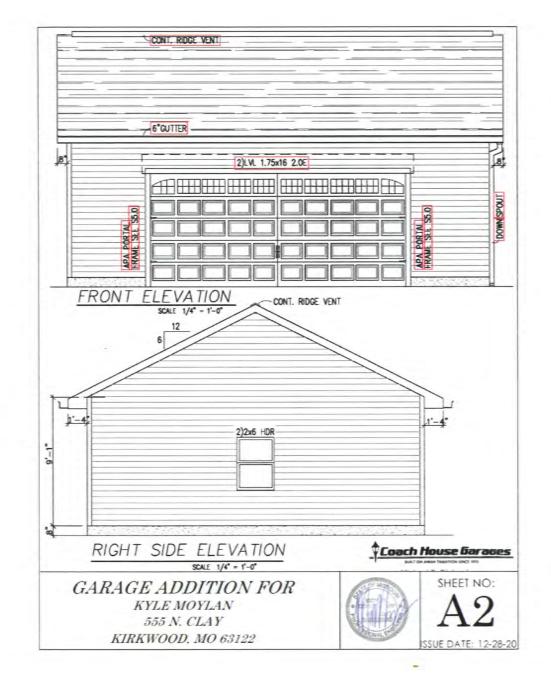



555 N. Clay - Elevations



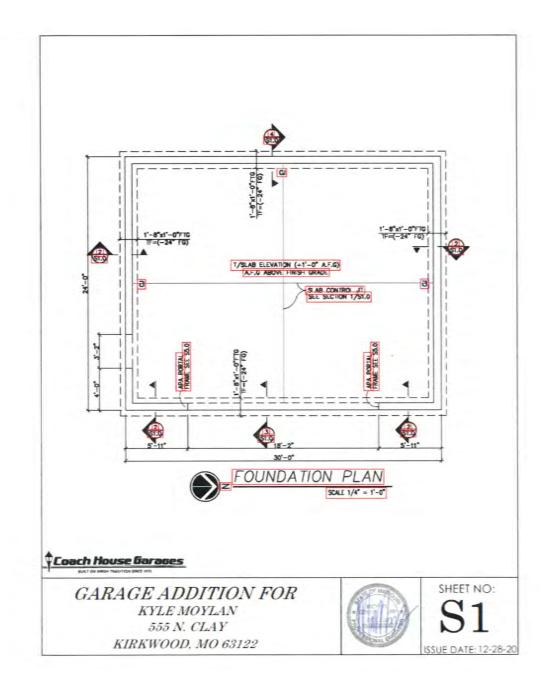



555 N. Clay - Elevations

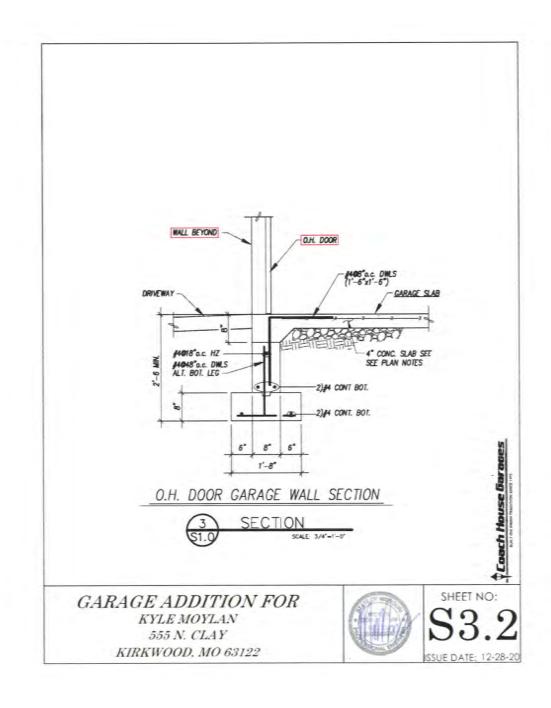

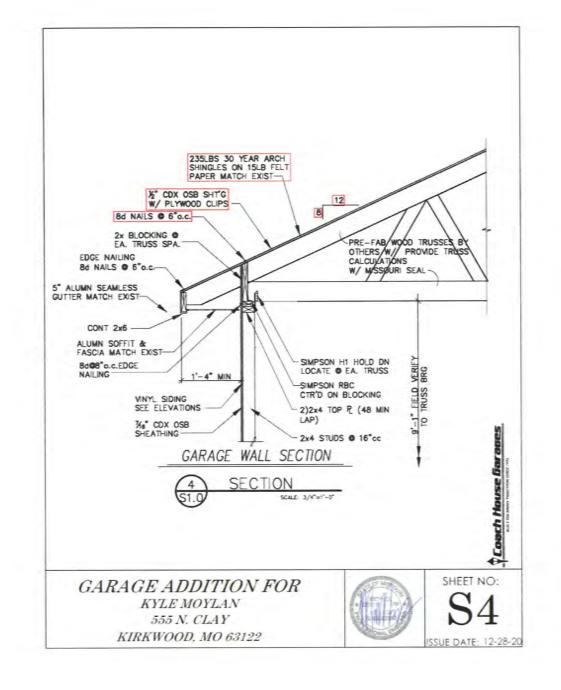


555 N. Clay – Site & Stormwater

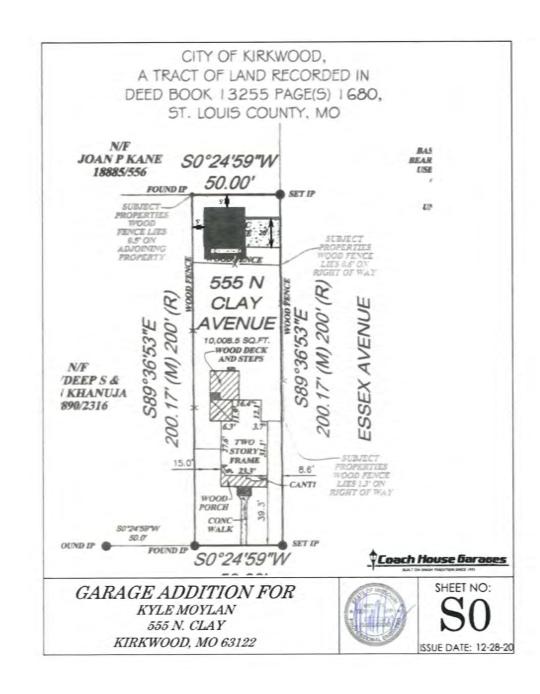

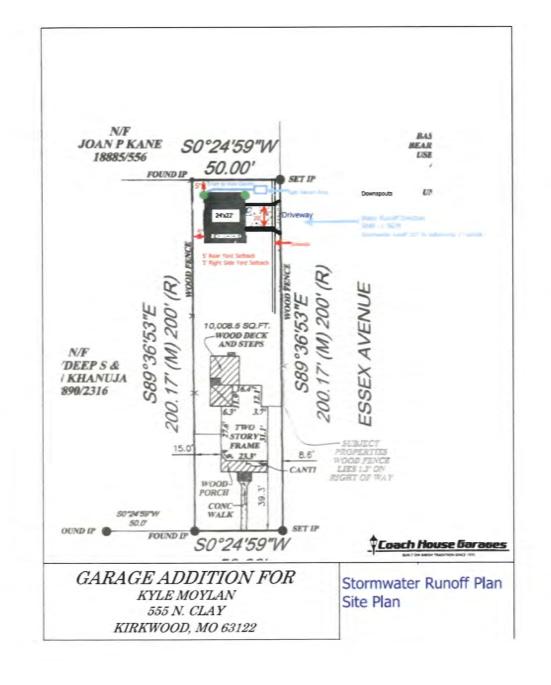

555 N. Clay – Site Photos

Owners Home

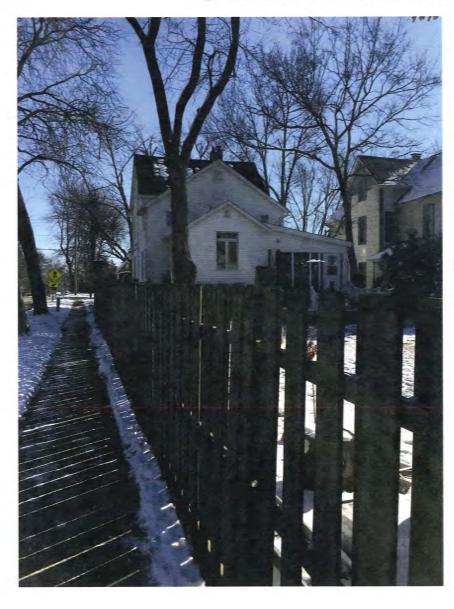

Neighbor



555 N. Clay — Site Photos

Garage Site



Garage Site




555 N. Clay — Site Photos

Neighbor




Neighbor

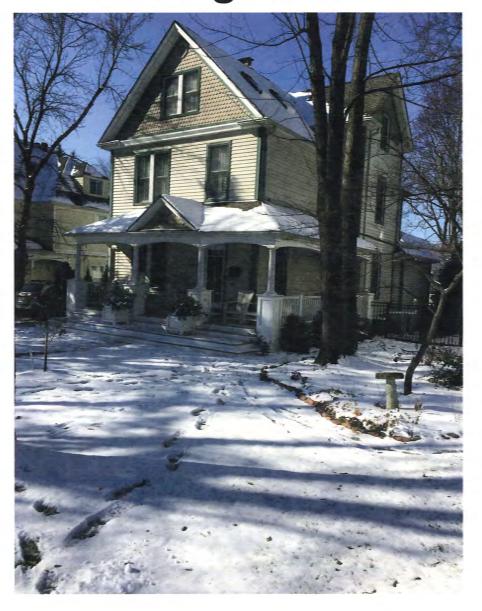

5 N.Clay – Contract, Material, Specificatio

Shingles – Black – Winterguard Ice & Watershield

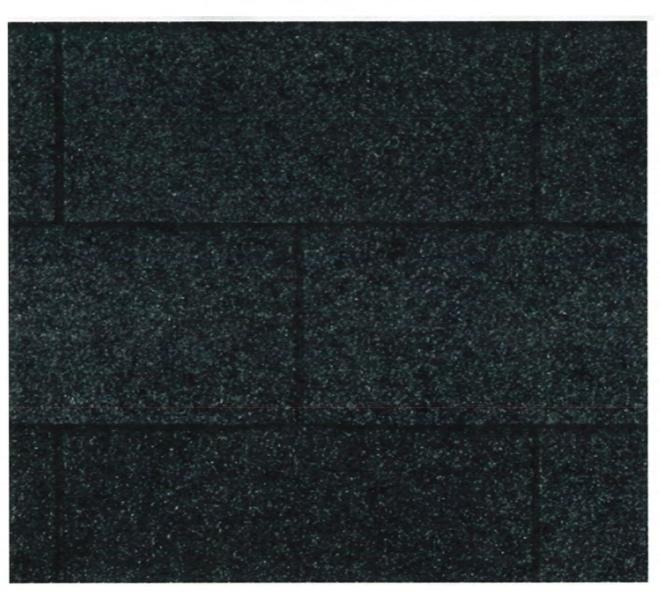

Siding - 4" Colonial White


5 N. Clay – Contract, Material, Specifications

All windows and doors trimmed with 3 ½ inch Colonial White Lineal

) - White - Stockton Glass - Spade Hardware



Simonton Profinish – White – Sin Hung with Colonial Grills

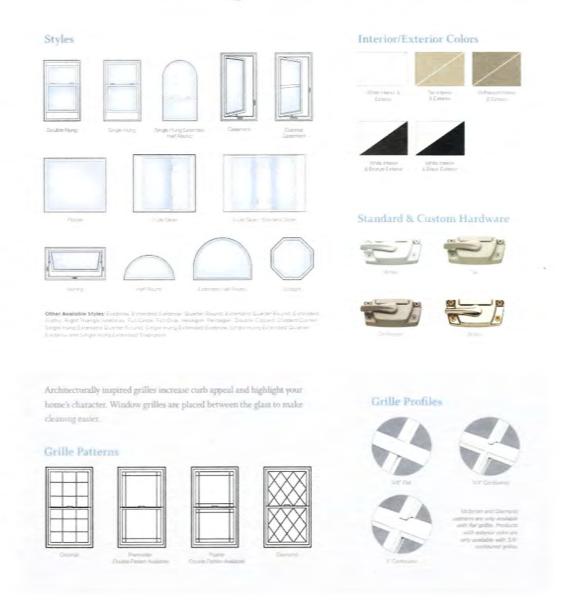

555 N.Clay – Contract, Material, Specifications

1-Wen 3'0" Exterior Door w/Glass





Architectural Review Board Application Additions & Detached Structures

DESIGN SUBMISSION APPLICATION

roperty Address 473 Long Fellow A	ve.	Zoned		
the property a Kirkwood Landmark? Yes	lo Ina	Local Historic District?	Yes N	lo
complete scope of work New Deck w/ R	of Rem	ove Existing Deck		
	ddition/\$100			100
	ICANT			
Name_ C.J. Moss		Phone 636-532	- 4054	
Address 620 Spirit Valley East Or				
City, State, Zip Chesterfield, Mo, 6				
E-mail (Agenda will be e-mailed to applicant)	noss ache	exterfield fance. com		
PROPER	TY OWNER			
Name Eric Peterson		Phone 310-991-	6369	
Address 473 Long fellow Ave.				6
City, State, Zip Kirkvood, Mo, 63122				
ARCHITECT	INFORMATIO			
Name C.J. Moss	20.9.0	Phone 636-5	32-405	-4
		/ N.		
Address 620 Spirit Velley East Dr.				
Address 620 Spirit Velley East Dr. City, State, Zip Chesterfield, Mo, 630	005			
Address 620 Spirit Velley East Dr. City, State, Zip Chasterfield, Mo, 630	005			
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agree to fully comply with the ordinances of	of the City o	f Kirkwood, including a	Architect	tura
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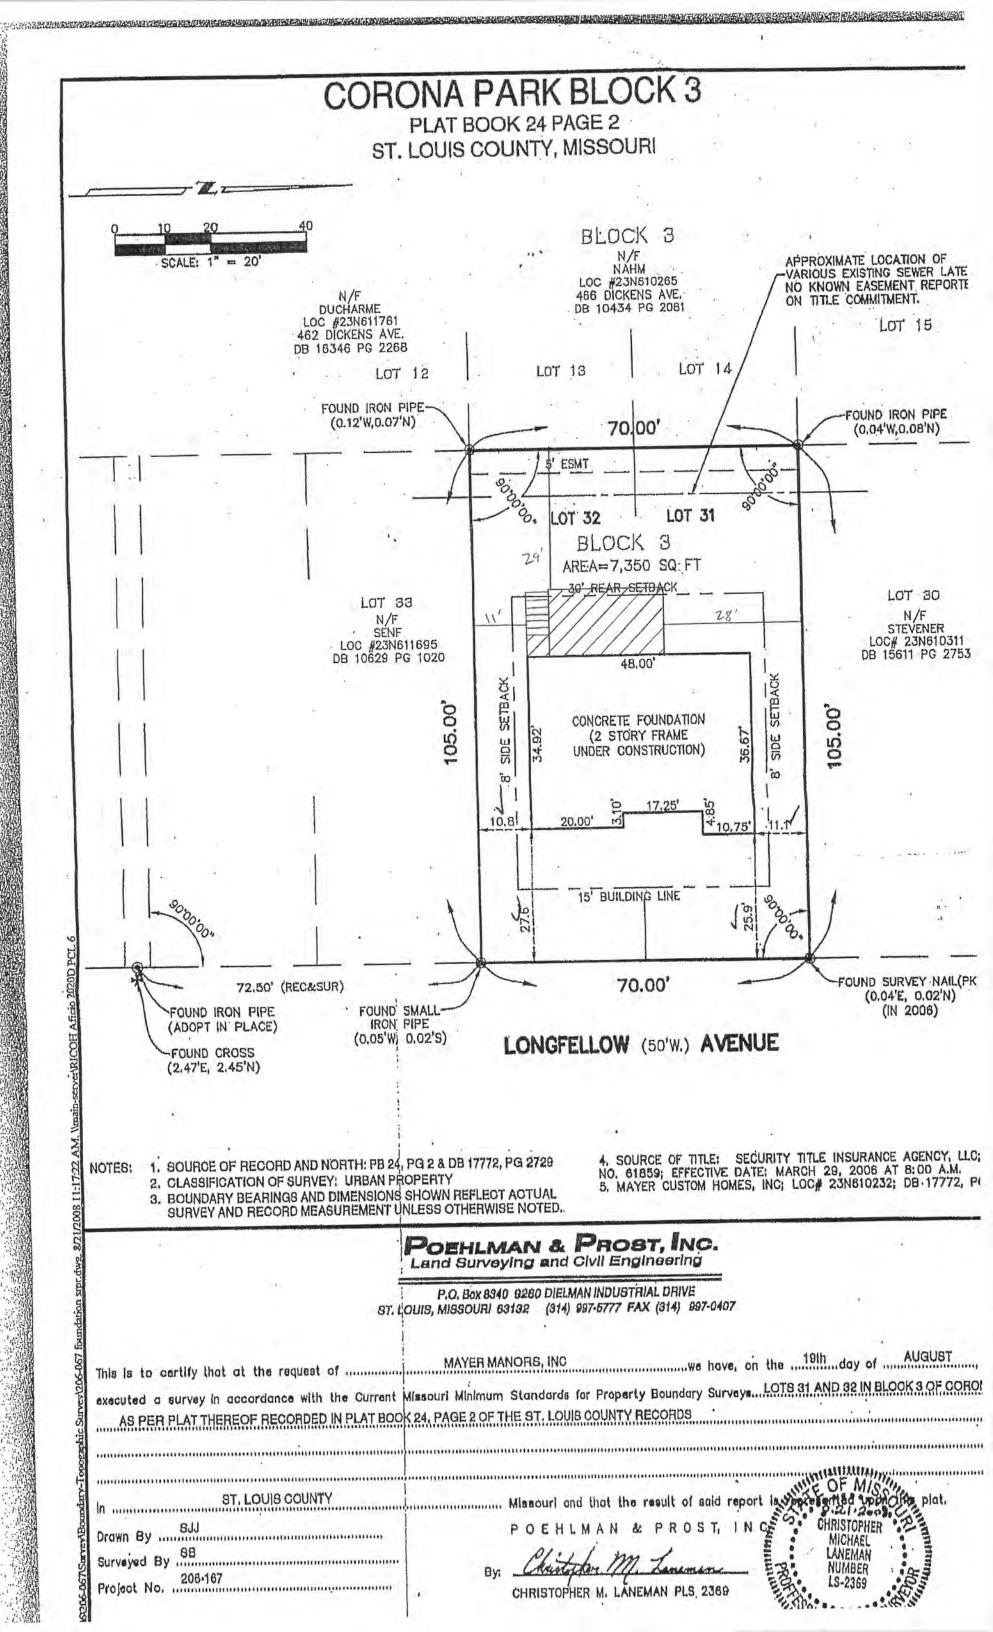
Architectural Review Board Application Additions & Detached Structures


PROJECT DESCRIPTION WORKSHEET

Secti	ion A: General Information
Natu	re of Application (Check all that apply):
×	Addition or Alteration
	Accessory Structure (Please Specify):
	Other (Please Specify):
Desc	ription of Work: Removal of Existing Deck; Construction of New Deck W/ Ro
Secti	on B: Site Context
1) <u>Bu</u>	ilding Form and Articulation
	tectural Style: Wood Dech with Gable Roof
Numl	ber of Stories: Building Height: Number of Roof Lines: L
Roof	Type: Primary Roof Pitch:
Seco	ndary Roof Pitch: Tertiary Roof Pitch:
	illding Materials
	ary Exterior Wall Material: Siding to Closely Match Existing Home's
	ndary Exterior Wall Material: N/A ary Wall Material V/A
	ary Roof Material: Shingles to Closely Match Existing Home
	ndary Roof Material: N/A
3) Ex	terior Windows and Doors
Туре	of Door: NA
Туре	of Window: N/A Pane Arrangement: N/A
4) <u>De</u>	etailing
Foun	dation Wall Covering: N/A
Loca	tion of Utility Equipment: N/A
Scree	ening of Utility Equipment:

Section C: Site Context Photos

Please attach to this application digital color photographs of all elevations of existing structures on the Subject Parcel. Photos must be a minimum 3"x4" size and may be on multiple pages:



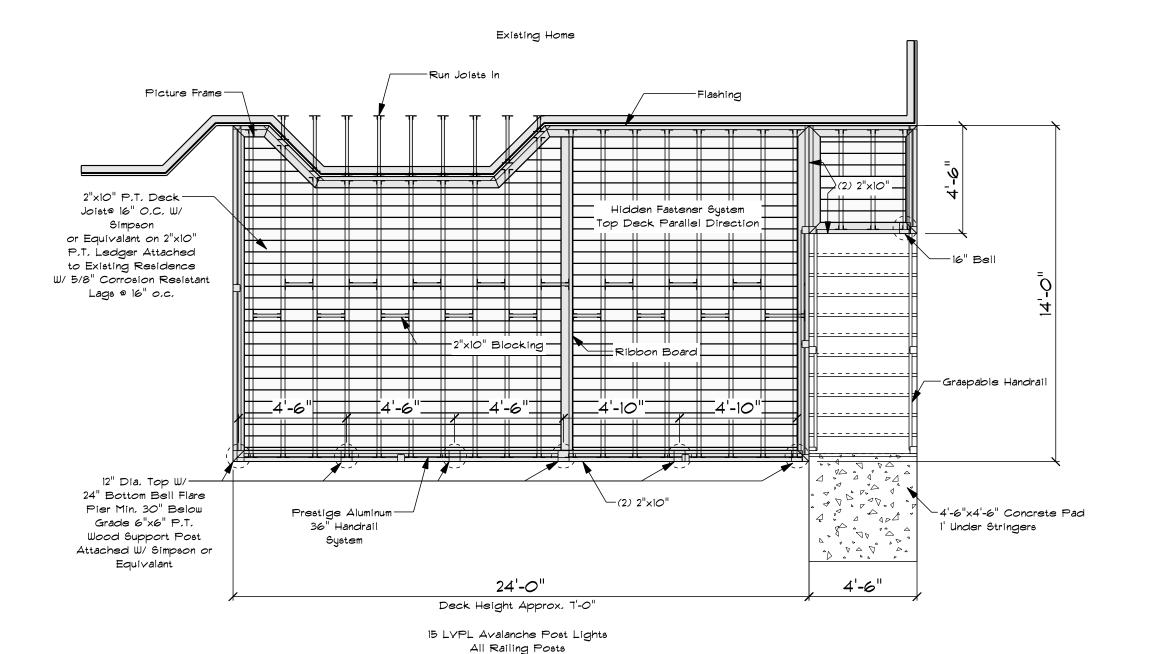

PROJECT: 54780

Chesterfield Fence & Deck
620 Spirit Valley East Dr.
Chesterfield MO 63005
CC
PHONE: 636-532-4054
FAX: 636-591-5488 PHONE: FAX: CELL:

CONSULTANT: Kevin Gallas

CHESTERFIELD

PAGE:


Deck Layout

Eric Peterson 473 Longfellow Ave. Kirkwood MO 63122 PHONE: 310-991-6369

DRAWN BY: C.J. Moss

DATE: 6/28/2021

Deck Layout SCALE: 1/4" = 1'-0"

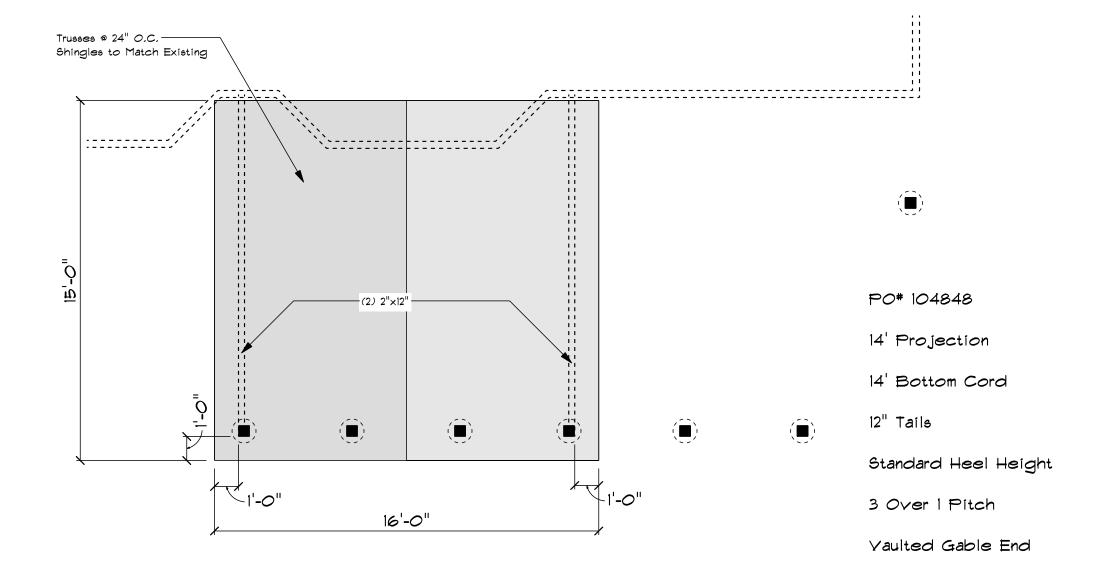

PROJECT: 54780

CHESTERFIELD SUN BOOMS

PAGE:

Roof Layout

DATE: 6/28/2021


Eric Peterson 473 Longfellow Ave. Kirkwood MO 63122 PHONE: 310-991-6369

DRAWN BY: C.J. Moss

CONSULTANT: Kevin Gallas

Chesterfield Fence & Deck
620 Spirit Valley East Dr.
Chesterfield MO 63005
PHONE: 636-532-4054
FAX: 636-532-8011
CELL: 636-591-5488

Roof Layout

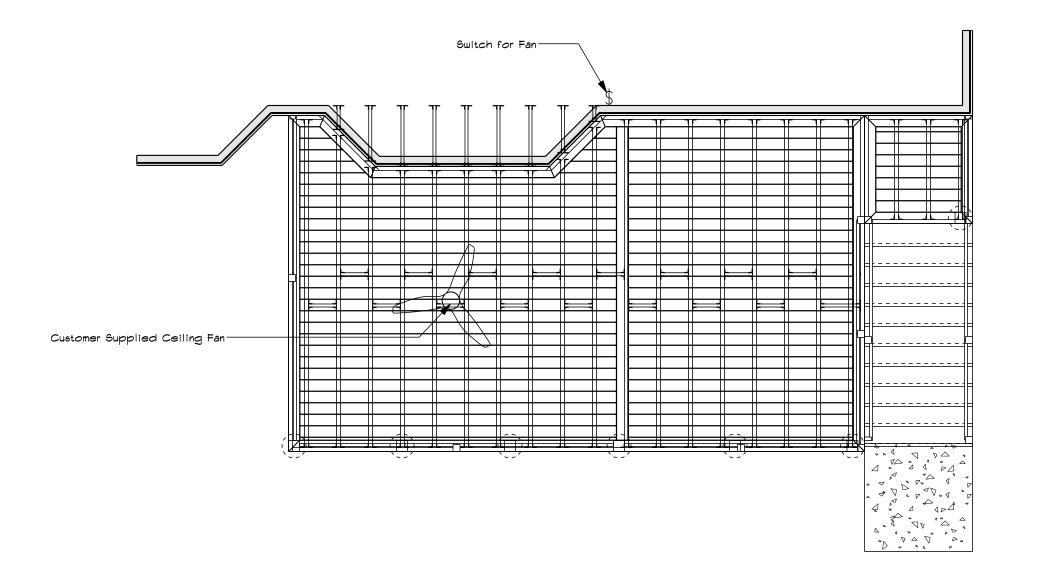

CHESTERFIELD S.U. N. R. O.O.M. S. by Chesterfield Ferroe & Deck

PROJECT: 54780

PAGE:

Electrical Layout

CONSULTANT: Kevin Gallas

Chesterfield Fence & Deck
620 Spirit Valley East Dr.
Chesterfield MO 63005
PHONE: 636-532-4054
FAX: 636-532-8011
CELL: 636-591-5488
cjmoss@chesterfieldfence.com


DRAWN BY: C.J. Moss

DATE: 6/28/2021

Eric Peterson 473 Longfellow Ave. Kirkwood MO 63122 PHONE: 310-991-6369

epeterson@spencerfane.com

Electrical Layout SCALE: 1/4" = 1'-0"

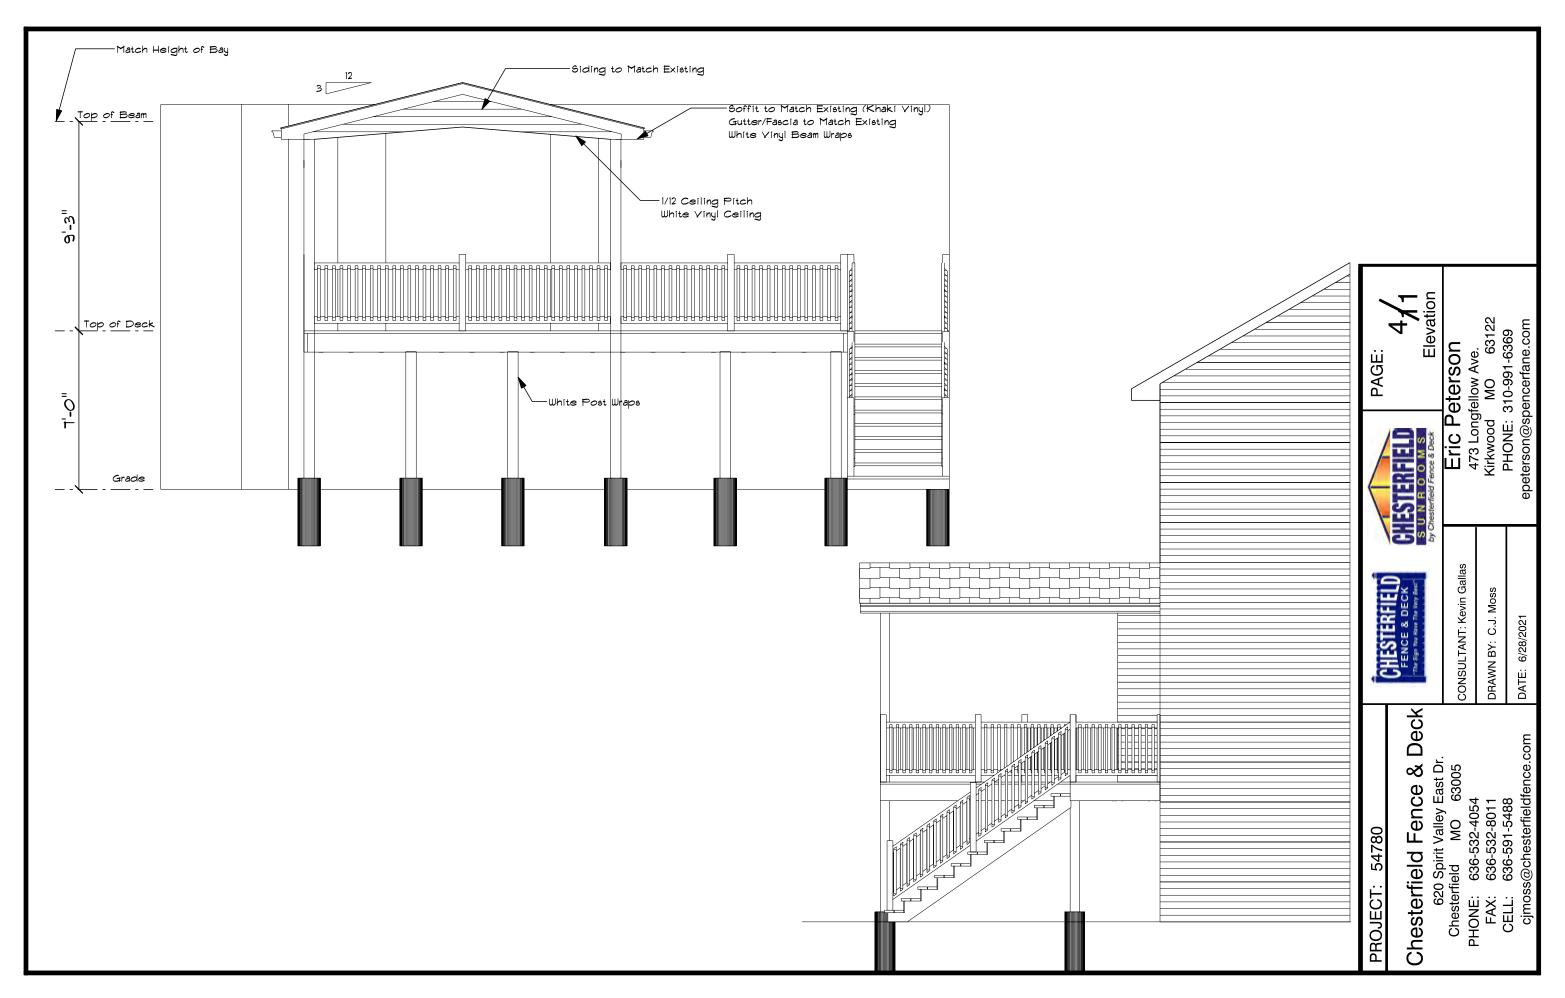

All Measurements Dimensions & Elevations Are Approximate And Are Subject To Change Due To Field Verification Of Such

Job Specific Notes: MCA # 1 P.T. KDAT Lumber For Framing Stairs Will Be Adjusted On Site Haul away tearout & job debris


Material:	Size:	Qty:	Color:	Remarks
Concrete Piers:				
Bottom Belled	See Plan	Per Plan		30" Below Grade
Cylindar	12" Dia.	Per Plan		Min. 6" Above Grade
Concrete Stringer Pad:	4'6"'x4'6"	Per Plan		Tuck 1' Under Stringers
Treated Lumber Sub Deck	<			
Joist	2"x10"	Per Plan		#1 P.T. KDAT @ 16" O.C. Att. W/ Simpson or Equivalent
Ledger Board	2"x10"	Per Plan		P.T. W/ (2) 5/8"x7" Lag Screws or Equivalent @ 15" O.C.
Beams	(2) 2"x10"	Per Plan		P.T. W/ Simpson Hangers or Equivalent
Support post	6"x6"	As Needed	White	P.T. W/ Simpson Post Base or Equivalent
Stair Stringer	2"x12"	AS Needed		P.T. @ 12" O.C. Attached W/ Simpson Or Equivalent
Deck Material:				
Top Deck	1"×6"	Per Plan	Espresso	Veka Top Deck (CCRR-0137 Pg. 1 Sec. 5.0) Parallel to Home
Picture Frame	1"×6"	Per Plan	Espresso	Picture Frame Deck Border
Top Deck Fasteners		As Needed		Hidden Fastener System
Fascia	1/2"x12"	Per Plan	Espresso	Wrapped W/ Veka Band Board Only
Stair Treads	10" Min.	Per Plan	Espresso	Veka Treads
Covered Risers	Closed	Per Plan	Espresso	Veka Risers Max Rise 7-3/4"
Handrail	36" High	Per Plan	Black	Prestige Aluminum
Graspable Handrail		Per Plan	Black	Prestige Aluminum
Handrail Post	4"×4"	Per Plan	White	Prestige Aluminum
Handrail Post Cap	4"×4"	Per Plan	White	Prestige Aluminum
Balusters	3/4"	As Needed	Black	Prestige Aluminum
Post Lights	NA	15	White	Avalanche Pyramid Post Lights





CONSULTANT: Kevin Gallas DRAWN BY: C.J. Moss


Chesterfield Fence & Deck
620 Spirit Valley East Dr.
Chesterfield MO 63005
PHONE: 636-532-4054
FAX: 636-532-8011
CELL: 636-591-5488


PROJECT: 54780

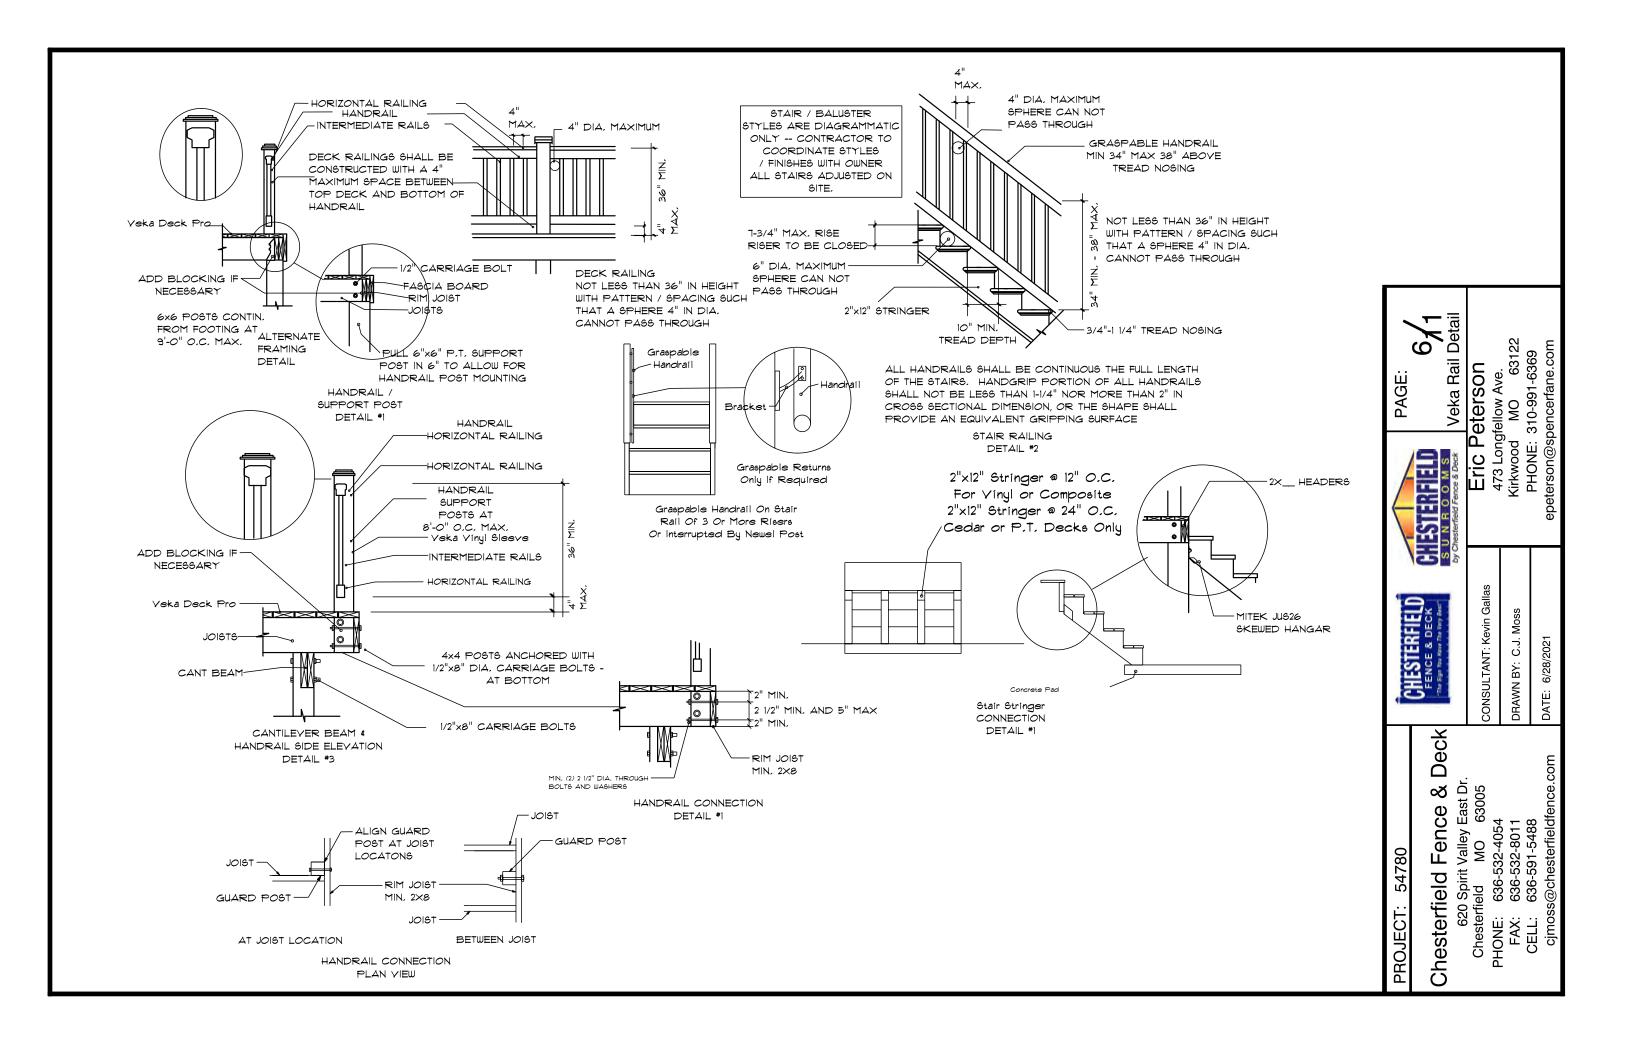


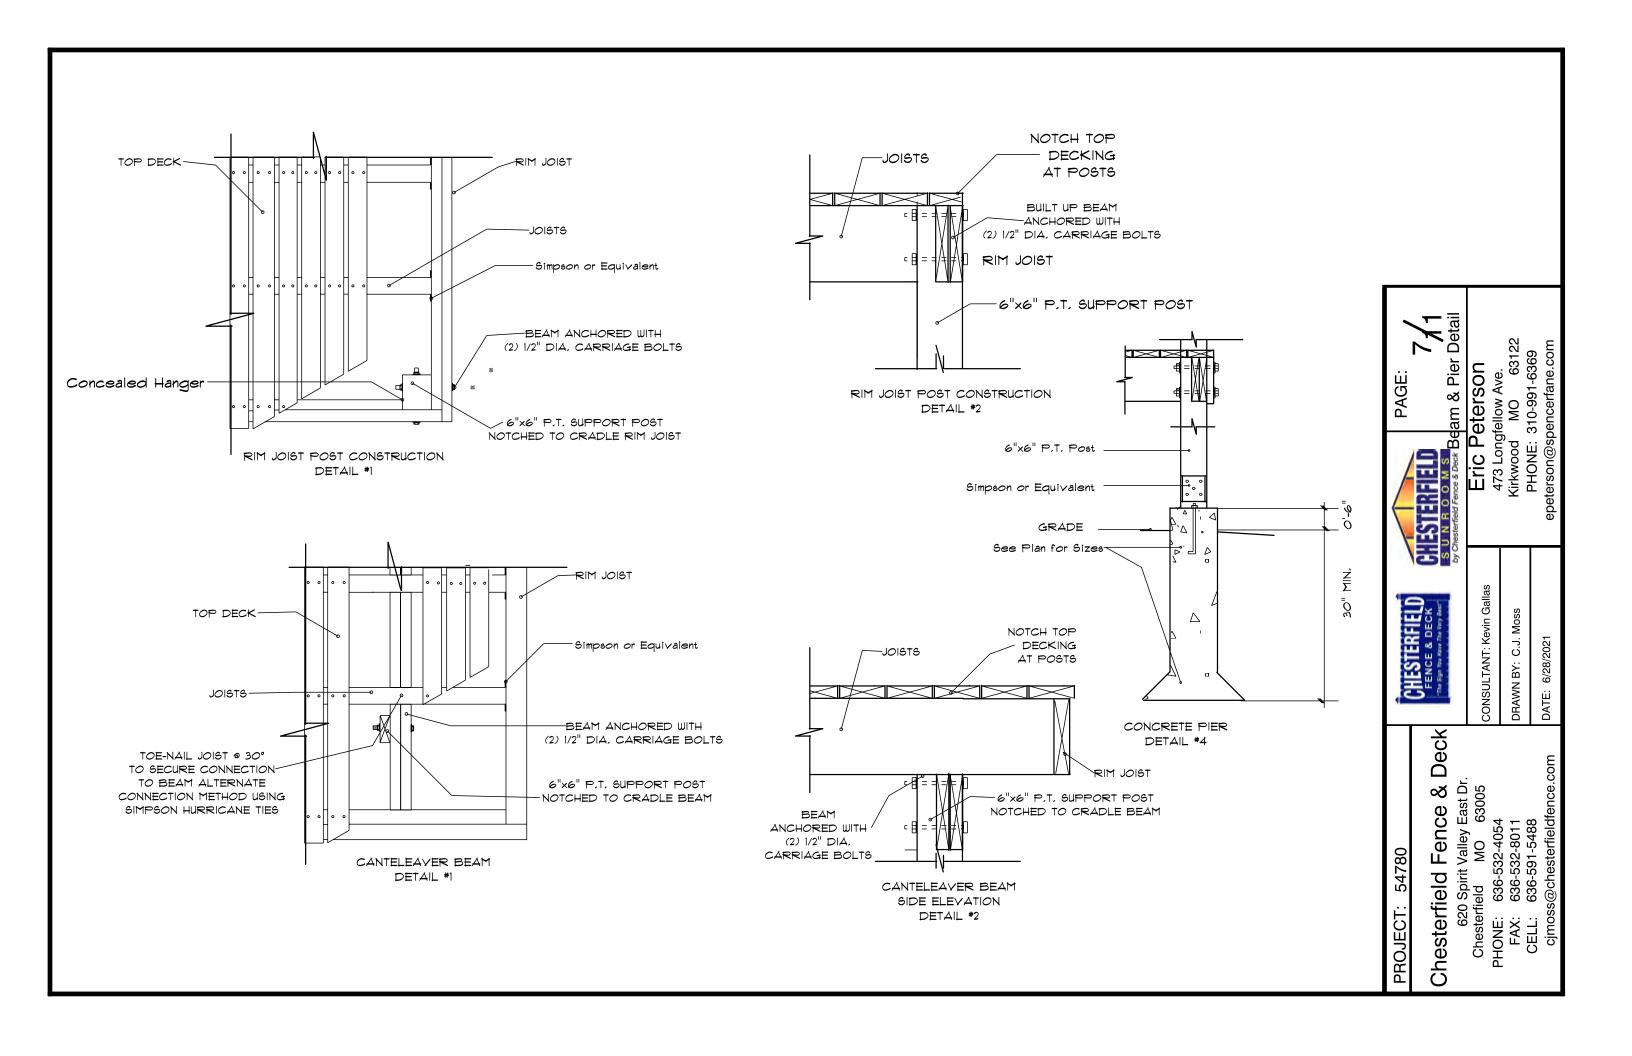

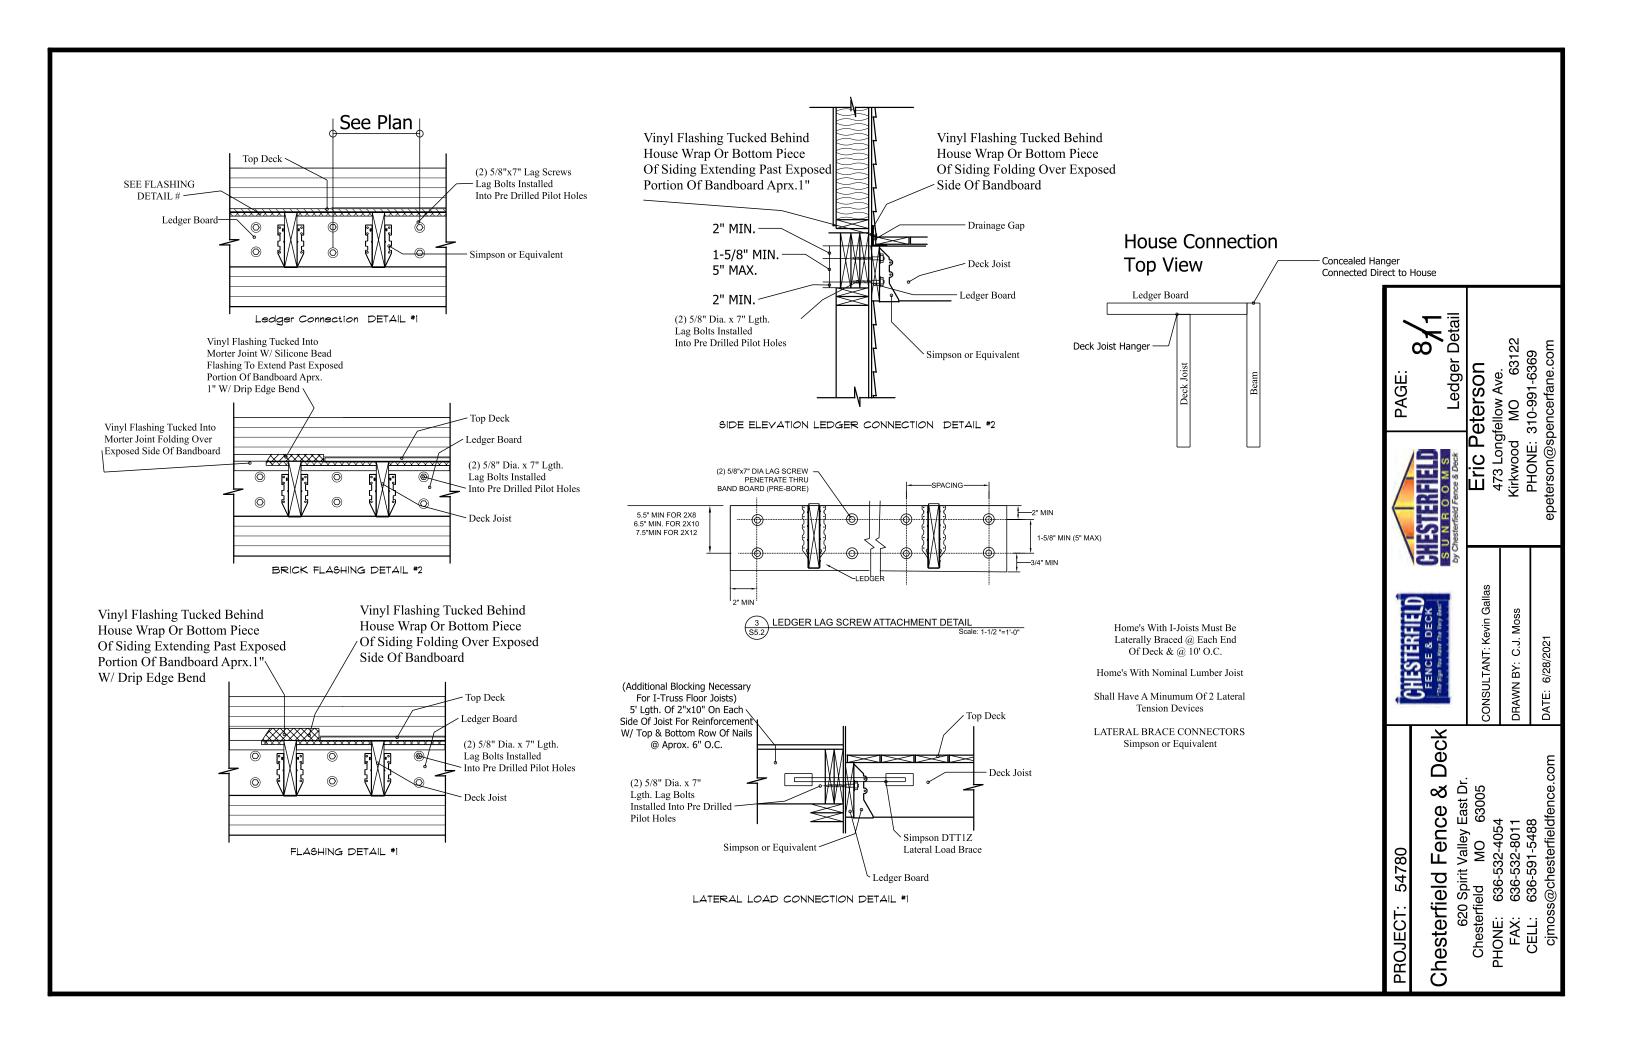

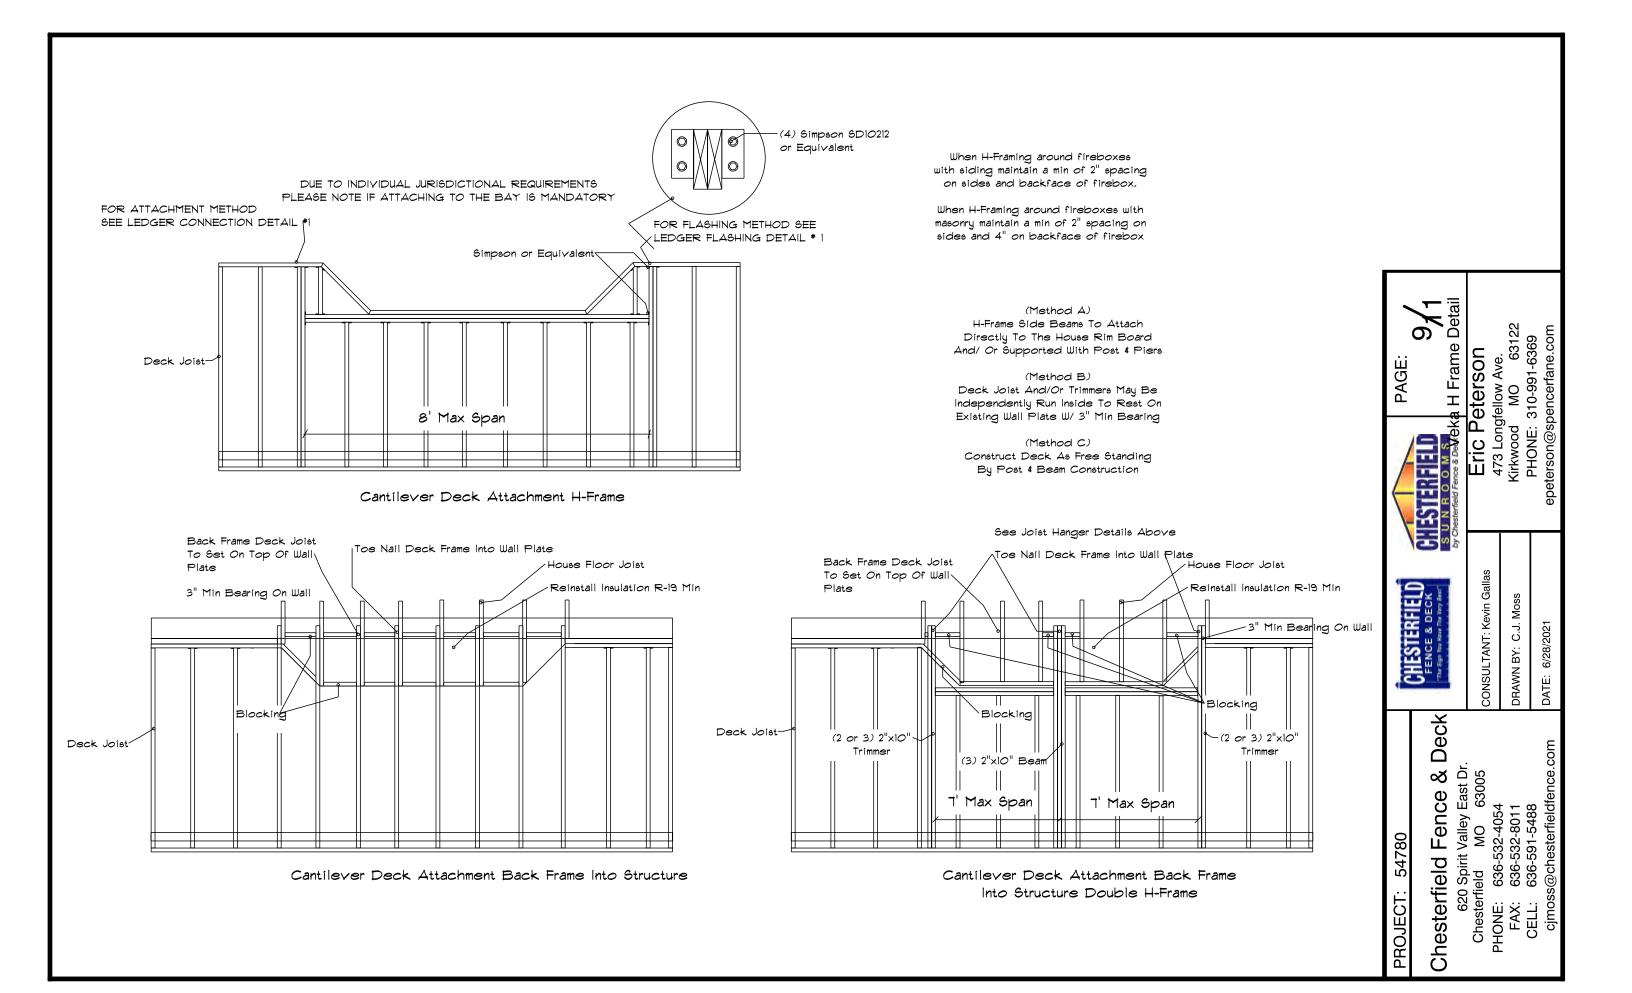


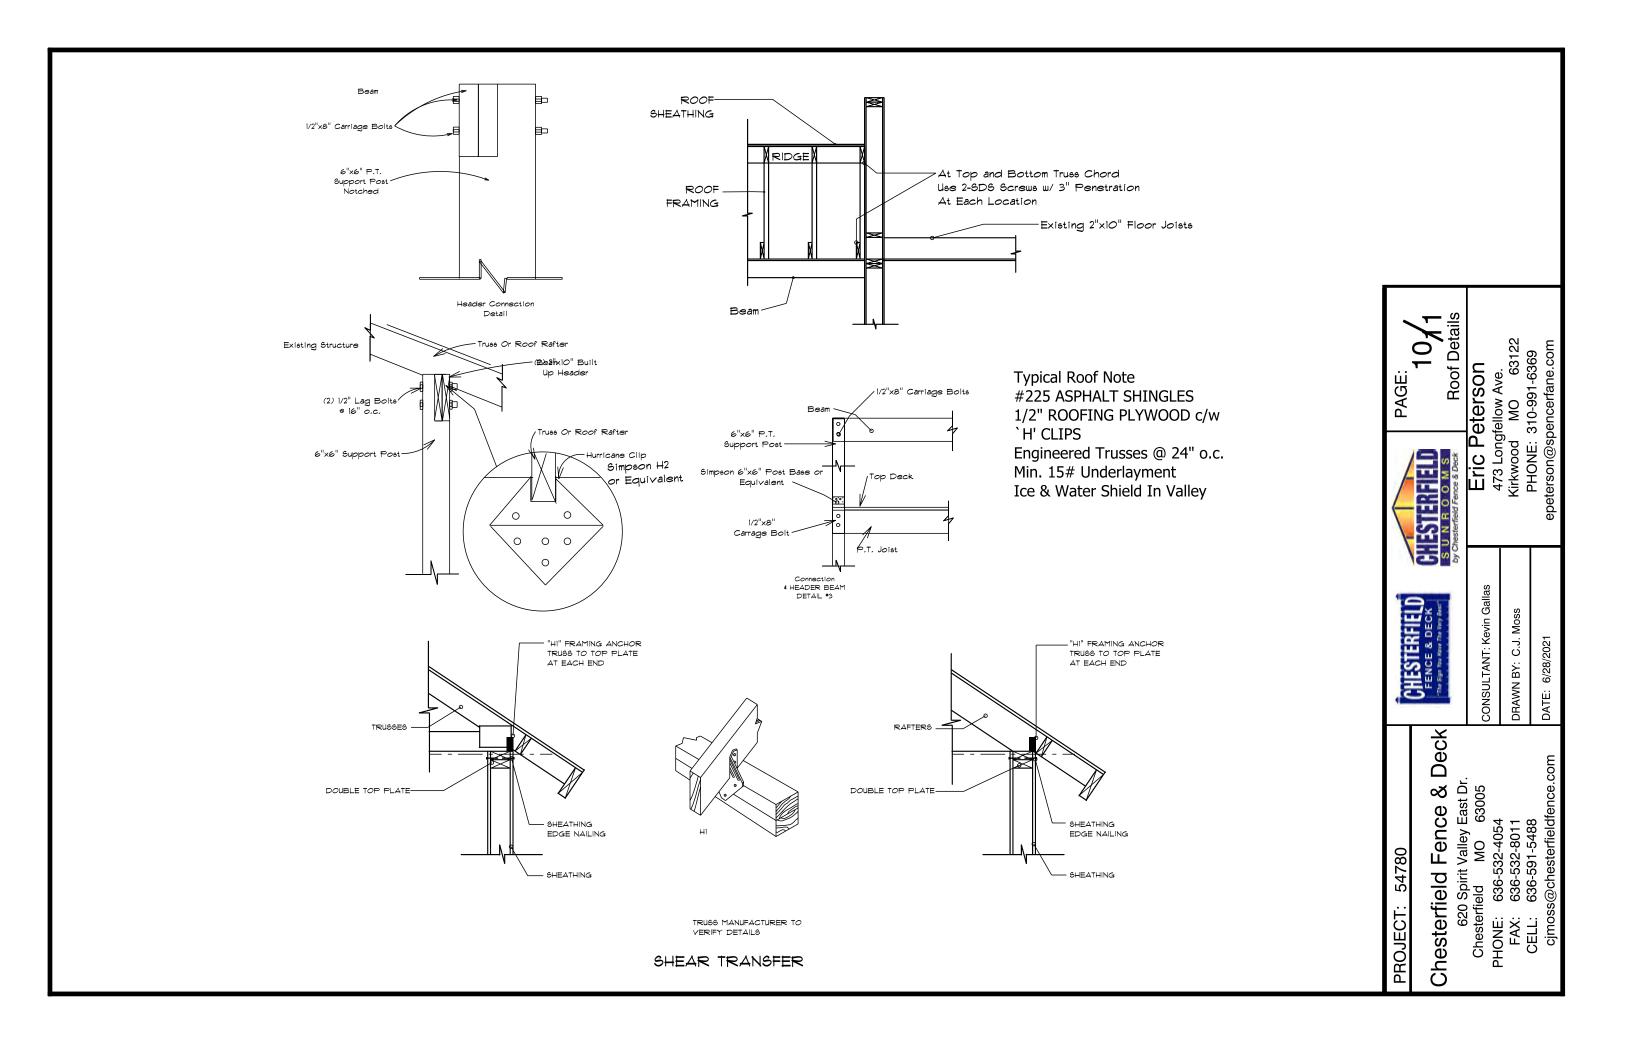

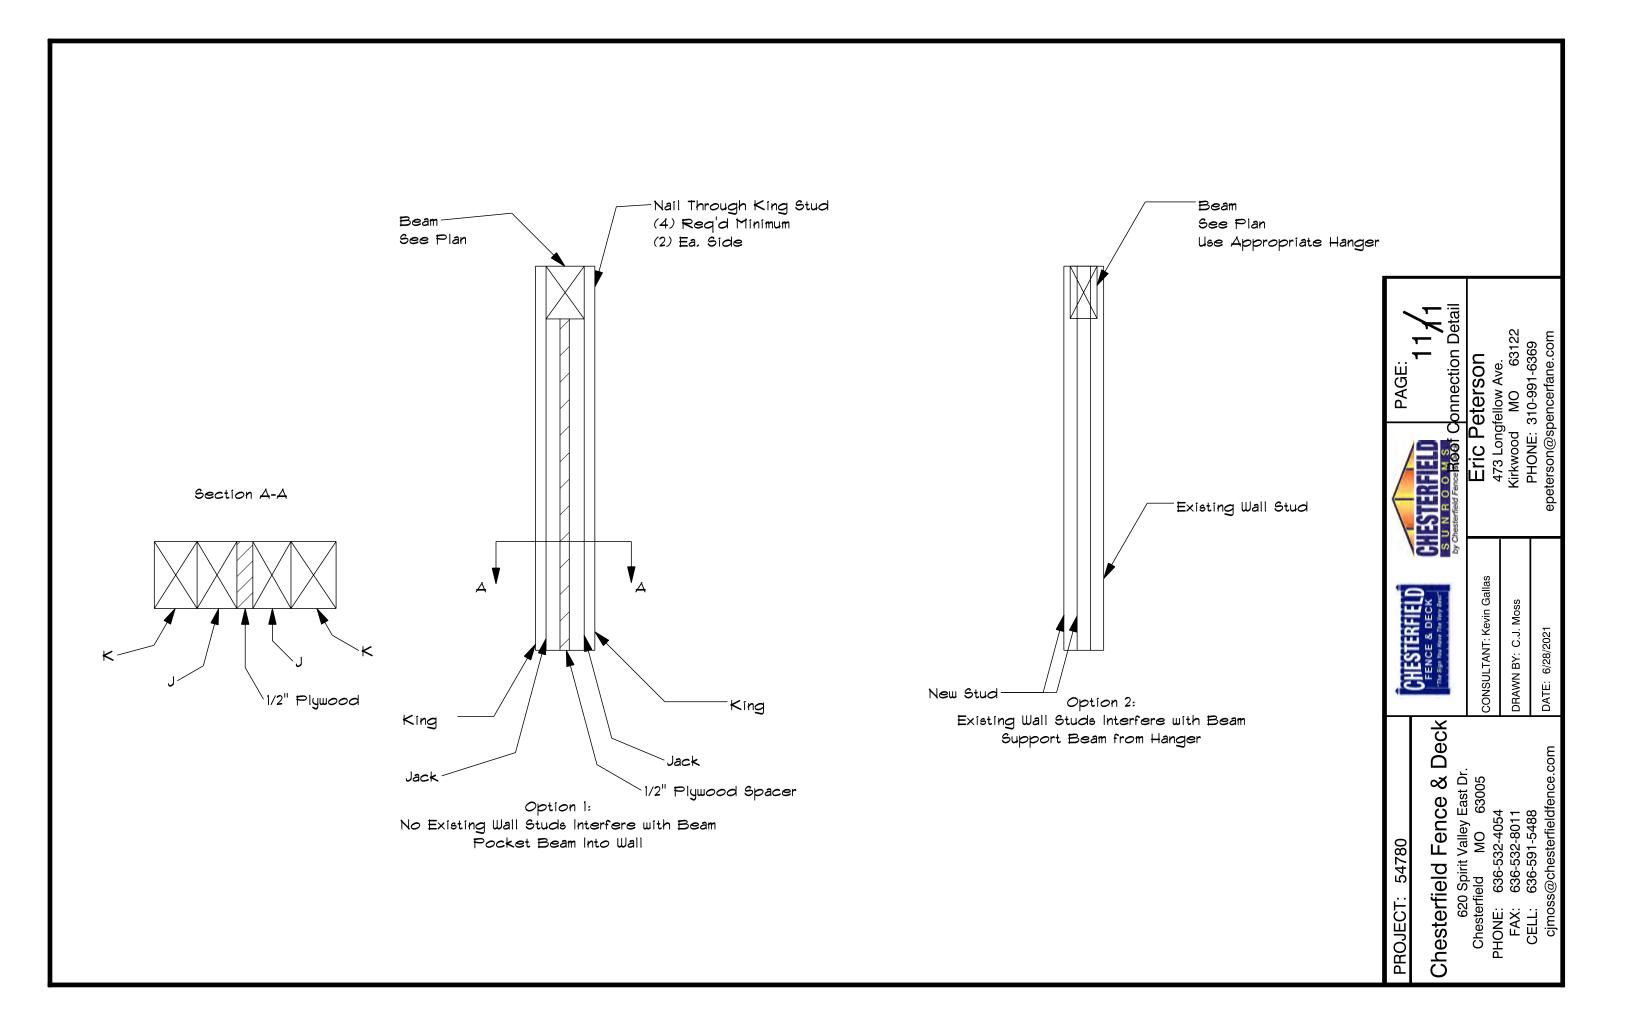





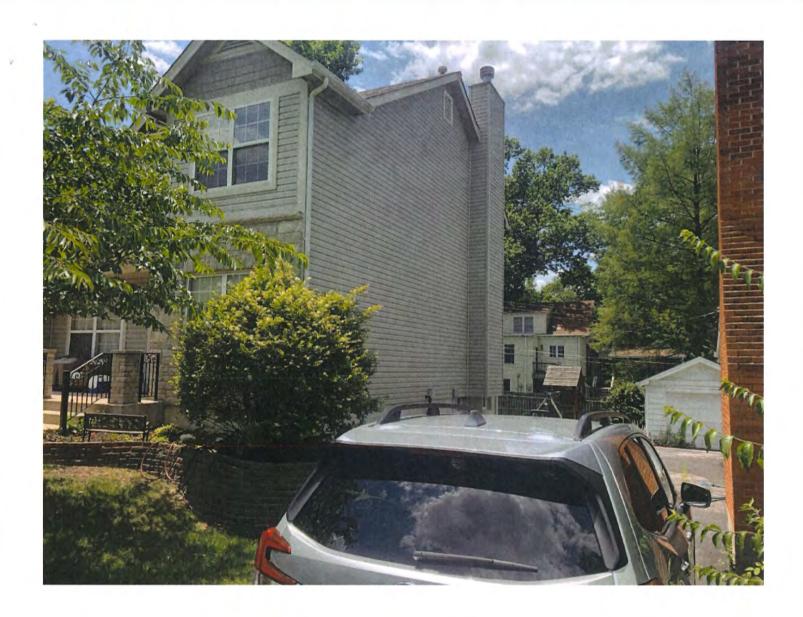





DESIGN SUBMISSION APPLICATION


: [- [- [- [- [- [- [- [- [- [a5 Rd Zoned X-3
Is the property a Kirkwood Landmark? You	es (No) In a Local Historic District? Yes (No)
Complete scope of work New Sin	
Construction Type/Fee: New House/\$150	2
	APPLICANT Ment Growt Phone 314-222-7088
City, State, Zip Stb Louis Mo	63117
E-mail (Agenda will be e-mailed to applicant)	inda. Clarke Manlindevelopment group, co
PRO	PERTY OWNER
Name	Phone
Address	
City, State, Zip	
I agree to fully comply with the ordinand Review, Zoning, Stormwater and Building	ces of the City of Kirkwood, including Architectural
the proposed work, and that I have been a	ht to construct, that the owner(s) of record authorizes authorized by the owner(s) to make this application as
the proposed work, and that I have been a	ht to construct, that the owner(s) of record authorizes authorized by the owner(s) to make this application as
the proposed work, and that I have been a their agent. Applicants or their represent	ht to construct, that the owner(s) of record authorizes authorized by the owner(s) to make this application as ative shall attend all meetings.
the proposed work, and that I have been a their agent. Applicants or their represent	th to construct, that the owner(s) of record authorizes authorized by the owner(s) to make this application as ative shall attend all meetings. Date Date CITY OF KIRKWOOD DUBLIC WORKS DEPARTMENT
Applicant's Signature City Use Only Received by	th to construct, that the owner(s) of record authorizes authorized by the owner(s) to make this application as ative shall attend all meetings. Date Date CITY OF KIRKWOOD DUBLIC WORKS DEPARTMENT




PROJECT DESCRIPTION WORKSHEET


	on A: General Information			
Nature of Application (Check all that apply):				
X	New Single Family Residence			
Accessory Structure (Please Specify):				
	Other (Please Specify):			
Description of Work: New Single Family home				
Secti	on B: Site Context			
1) <u>Bu</u>	ilding Form and Articulation			
Archi	rectural Style:			
	per of Stories:Building Height:Number of Roof Lines:			
Roof	Type: HSPlatt Primary Roof Pitch:			
Seco	ndary Roof Pitch: Tertiary Roof Pitch:			
2) <u>Bu</u>	ilding Materials			
Prima	ry Exterior Wall Material: Ving Siding			
Seco	ndary Exterior Wall Material: Viny Road & Batter			
Tertia	ry Wall Material			
Prima	ry Roof Material: ASPORT Architectural Took Shingles			
Seco	ndary Roof Material:			
3) Ex	terior Windows and Doors			
	of Door:			
	of Window: Viny Pane Arrangement: Opane grid			
4) <u>De</u>	tailing			
Found	dation Wall Covering:			
Locat	ion of Utility Equipment:			
Scree	ning of Utility Equipment:			
Secti	on C: Neighborhood Context (New Primary Construction Only)			
	[4] 아그리아(1948) 1948 (1948) 1945 (1948) 1948 (1948) 1948 (1948) 1948 (1948) 1948 (1948) 1948 (1948) 1948 (1948)			
your l	ial Palette: Any material present on 20% or more of the front facades of existing houses within Neighborhood Context is considered a Predominant Material (there may be more than one). If a material is dominant on more than 70% of the houses within the site context that material is dered to be the Single Dominant Material.			
	Dominant Material: Siding			
Predo	ominant Material: Vinyl Board & Platten			



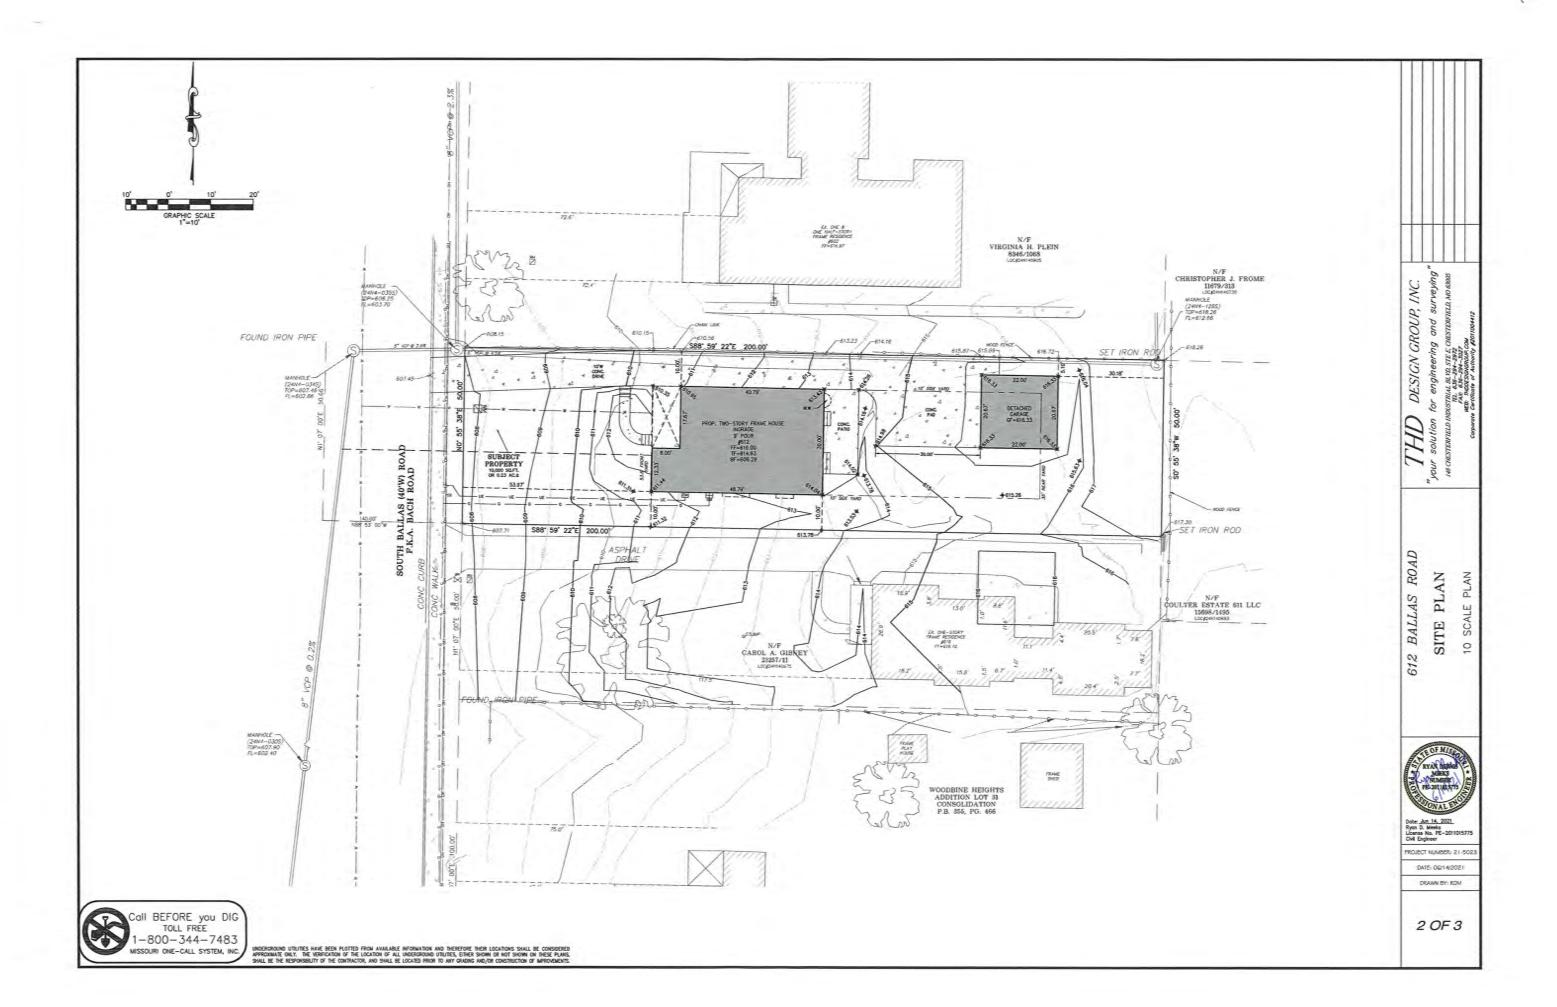

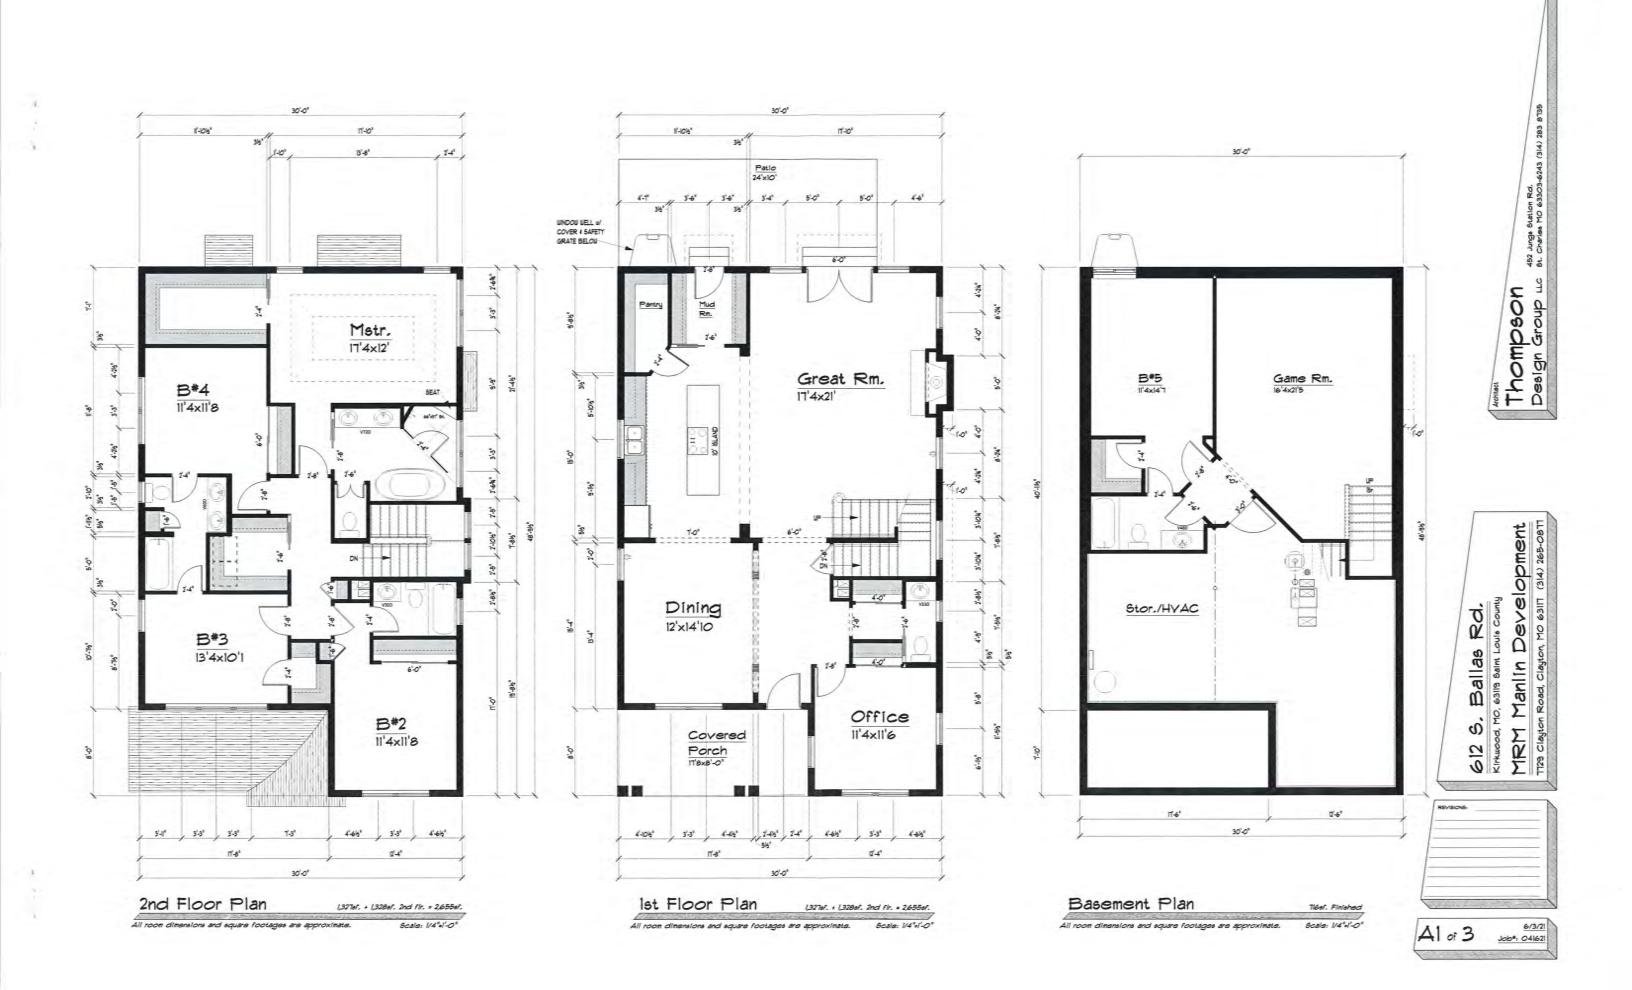



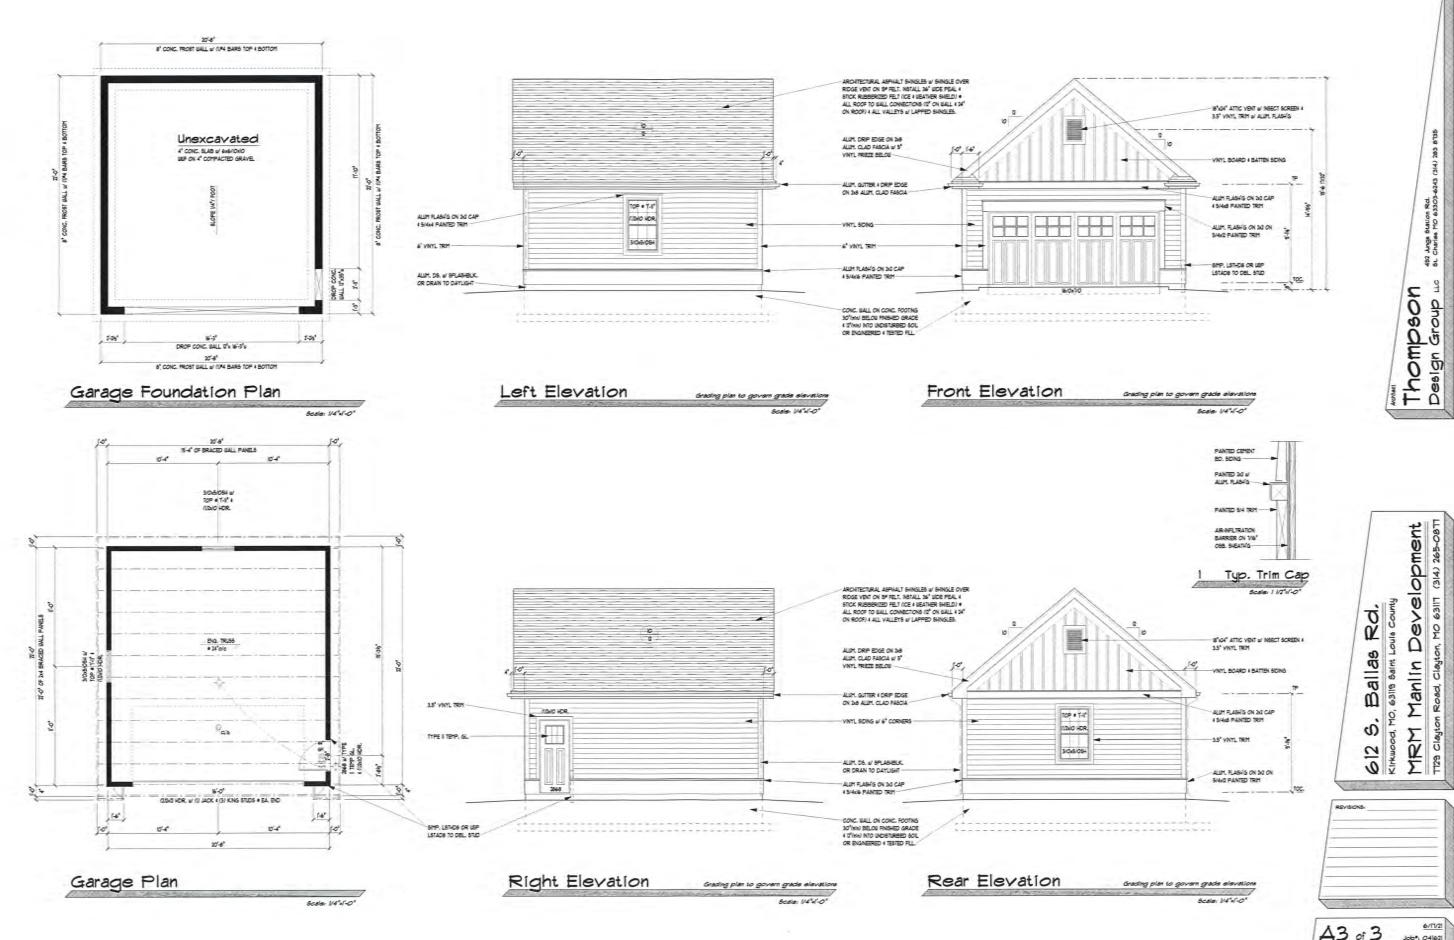

A3 of 3 Job*: 04|62|









528 S. Ballas (Photo 1)



532 S. Ballas (Photo 2)



602 S. Ballas (Photo 3)



616 S. Ballas (Photo 4)



624 S. Ballas (Photo 5)



704 S. Ballas (Photo 6)



519 S. Ballas (Photo 7)



529 S. Ballas (Photo 8)




1708 Janet PI - Vacant (Photo 9)



615 S. Ballas (Photo 10)



705 S. Ballas (Photo 11)

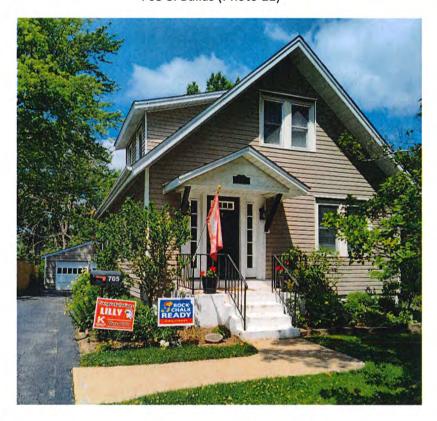

711 S. Ballas (Photo 12)



717 S. Ballas (Photo 13)





DESIGN SUBMISSION APPLICATION


APPLICANT ame NRM Manin Calemant Group Phone 3/5 didress 7729 Clayfon Rd ty, State, Zip St. Louis, Mo. 63117 PROPERTY OWNER ame Phone Phone ARCHITECT INFORMATION ame Name Station Rd ty, State, Zip Phone Station Rd ty, State, Zip Phone Station Rd ty, State, Zip Station Rd ty, Sta	d
APPLICANT Phone 3/5 Addition/\$100 Accessory Str APPLICANT Phone 3/5 Architect information ARCHITECT I	District? Yes (No)
APPLICANT ame NRM Manin Calemant (prop Phone 3/2) didress 7729 Clayton Rot try, State, Zip St. Louis, Mo. 63117 mail (Agenda will be e-mailed to applicant) PROPERTY OWNER ame Phone Phone didress try, State, Zip ARCHITECT INFORMATION ame Nompson Design Group Phone 3/2 didress 452 Jungs Station Rot try, State, Zip St Charles Mo. 63263 gree to fully comply with the ordinances of the City of Kirkwood, inview, Zoning, Stormwater and Building regulations. I hereby certify that property for which I have the legal right to construct, that the owner(s) to main agent. Applicants or their representative shall attend all meetings. Dilicant's Signature ity Use Only genda Date 0106/2021 ase # 70 24 P genda Date 0106/2021 ase # 70 24 P genda Date 0106/2021 ase # 70 24 P genda Comments Need Occurate Spot great to calculate only only only only only only only only	
Phone 3/2 Iddress 7729 (auton Rot	ucture or Other/\$100
PROPERTY OWNER ame	1-222-7088
PROPERTY OWNER ame	
ARCHITECT INFORMATION Phone 3/5 Architect Information Architect Information Phone 3/5 Architect Information Architect Information Phone 3/5 Architect Information Phone 3/5 Architect Information Archit	
ARCHITECT INFORMATION ARCHITECT INFORMATION ARCHITECT INFORMATION ARCHITECT INFORMATION ARCHITECT INFORMATION Phone 3/5 diverse to fully comply with the ordinances of the City of Kirkwood, inview, Zoning, Stormwater and Building regulations. I hereby certify that property for which I have the legal right to construct, that the owner(s) proposed work, and that I have been authorized by the owner(s) to mair agent. Applicants or their representative shall attend all meetings. Dilicant's Signature ity Use Only genda Date 07 106 2021 ase # 78 24 2 permit # 22 100 oning Comments Need Occurate Spot great to calculate the construct.	
ARCHITECT INFORMATION ame hompson Design Group Phone 3/5 didress 452 Jungs Station Rd ity, State, Zip Station Rd gree to fully comply with the ordinances of the City of Kirkwood, inview, Zoning, Stormwater and Building regulations. I hereby certify that property for which I have the legal right to construct, that the owner(s) proposed work, and that I have been authorized by the owner(s) to mair agent. Applicants or their representative shall attend all meetings. Dicant's Signature ity Use Only genda Date 07 106 2021 ase # 78 24 2 permit # 22 100 coning Comments Need Occurate Spot great to calculate the contract of the City of Kirkwood.	
didress 452 Jungs Station Rd. The state of the City of Kirkwood, inview, State, Zip Stormwater and Building regulations. I hereby certify that property for which I have the legal right to construct, that the owner(s) proposed work, and that I have been authorized by the owner(s) to mair agent. Applicants or their representative shall attend all meetings. The state of the City of Kirkwood, inview, Zoning Stormwater and Building regulations. I hereby certify that proposed work, and that I have been authorized by the owner(s) to mair agent. Applicants or their representative shall attend all meetings. The state of the City of Kirkwood in the city	
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eceived by TD genda Date 07/06/2021 ase # 78 24 (2 ermit # 22 120) ching Comments Need accurate Soot great to calculate the	6/18/2027
eceived by TD genda Date 07 06 2021 ase # 78 24 2 ermit # 22 120) CITY OF KIRKWOOD oning Comments Need accurate Seat great to calculate the	Date
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uilding Comments	




PROJECT DESCRIPTION WORKSHEET


Section	on A: General Information			
Nature	e of Application (Check all that apply):			
X	New Single Family Residence			
	Accessory Structure (Please Specify):			
	Other (Please Specify):			
Description of Work: New Single Family Home				
Section	on B: Site Context			
1	ectural Style: Tractition			
	er of Stories: Building Height: <u>30' 6"</u> Number of Roof Lines:			
Roof 7	Гуре: Asphalt Primary Roof Pitch:			
Secon	ndary Roof Pitch: Tertiary Roof Pitch:			
2) <u>Bui</u>	Iding Materials			
Prima	ry Exterior Wall Material: Viryl Siden			
	ndary Exterior Wall Material: Vingle Board of Batter			
Tertia	ry Wall Material			
Prima	ry Roof Material: Architectural Roof Shingles			
	ndary Roof Material:			
	erior Windows and Doors			
Туре	of Door: Fiberglass			
Туре	of Window: Vingle Pane Arrangement: divided wight			
4) De				
Found	dation Wall Covering:			
Locat	ion of Utility Equipment:			
Scree	ning of Utility Equipment:			
Secti	on C: Neighborhood Context (New Primary Construction Only)			
your I	ial Palette: Any material present on 20% or more of the front facades of existing houses within Neighborhood Context is considered a Predominant Material (there may be more than one). If a material is dominant on more than 70% of the houses within the site context that material is dered to be the Single Dominant Material.			
Single	e Dominant Material:			
Predo	ominant Material:			



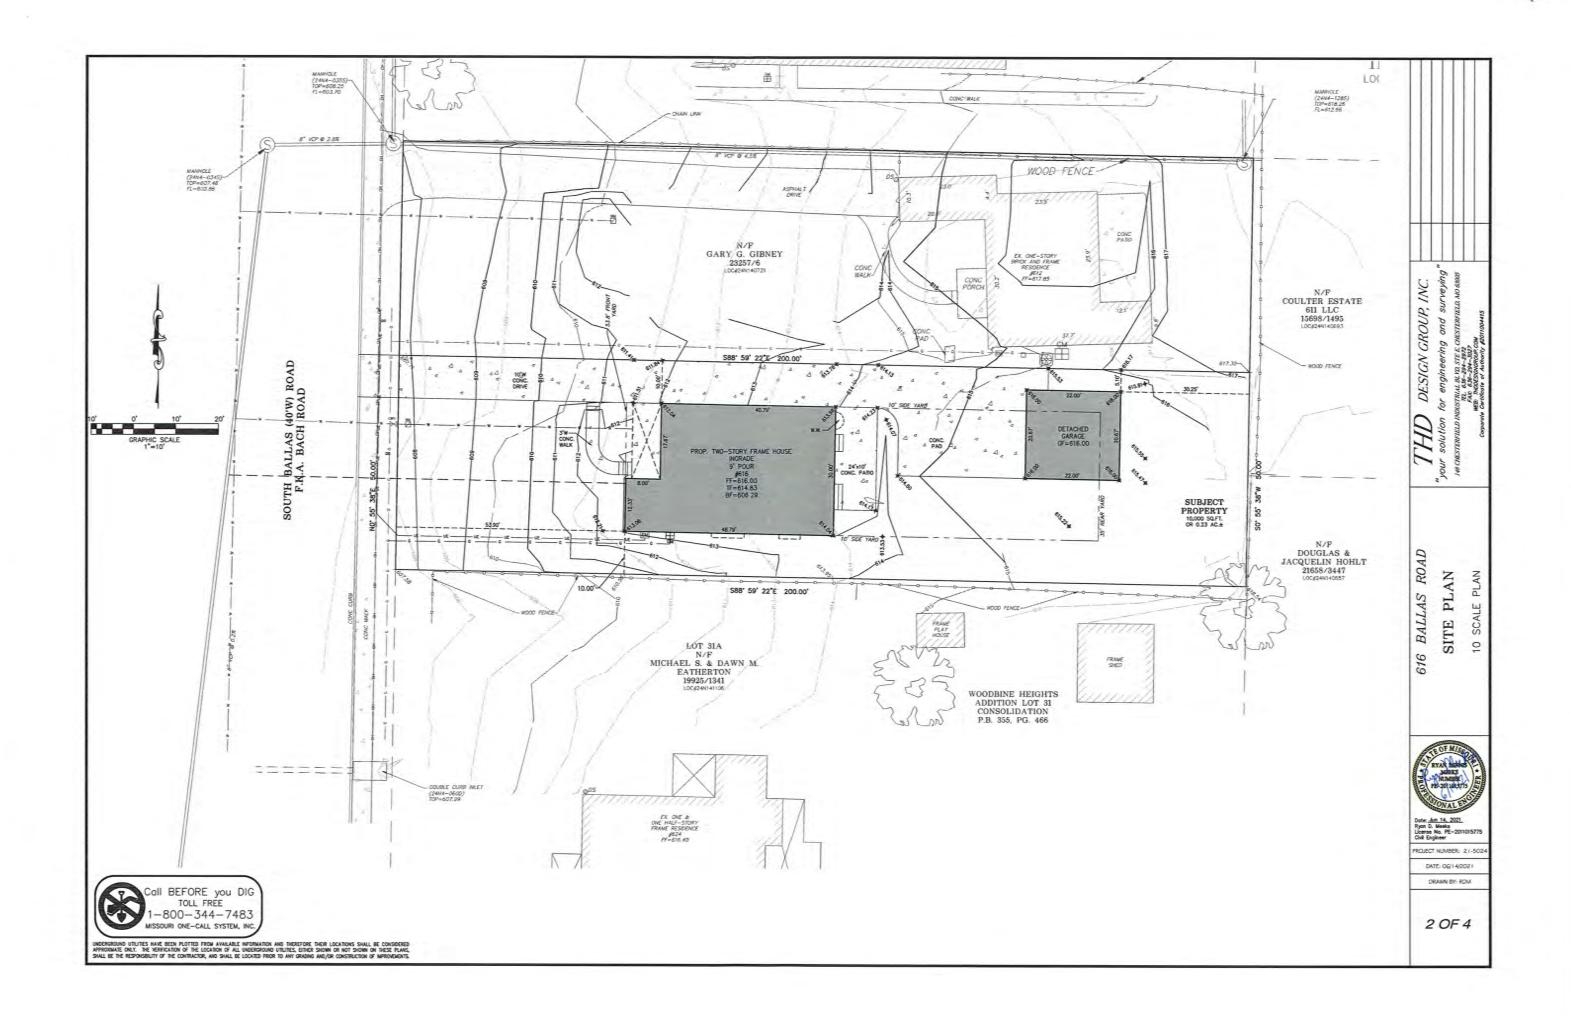

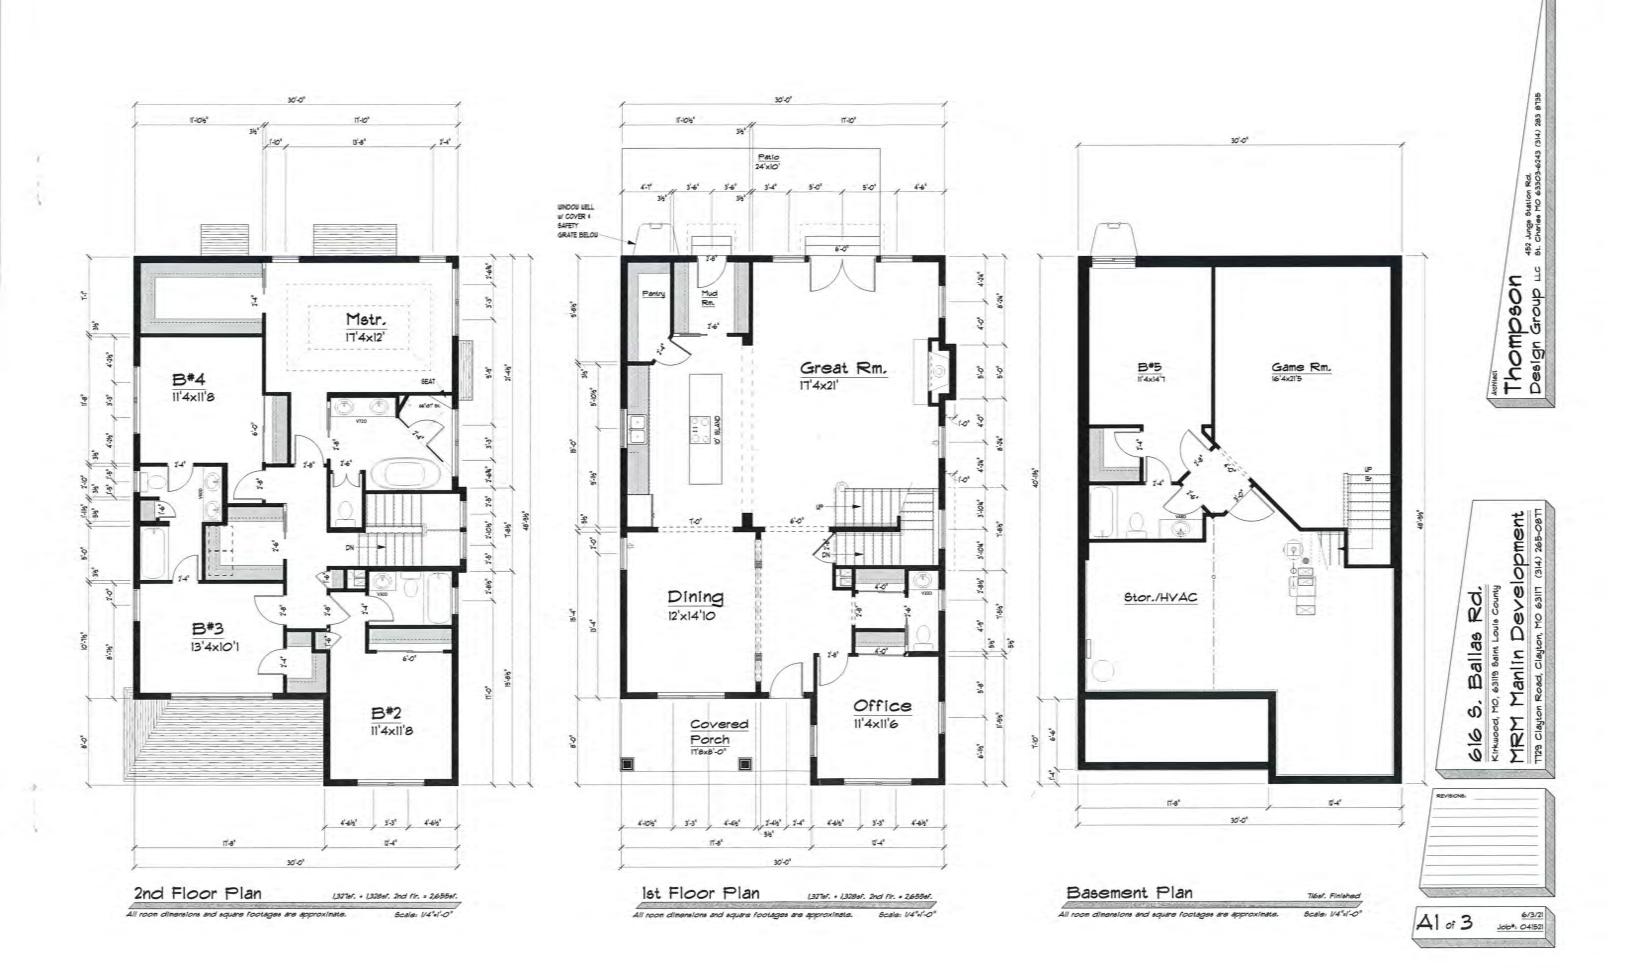




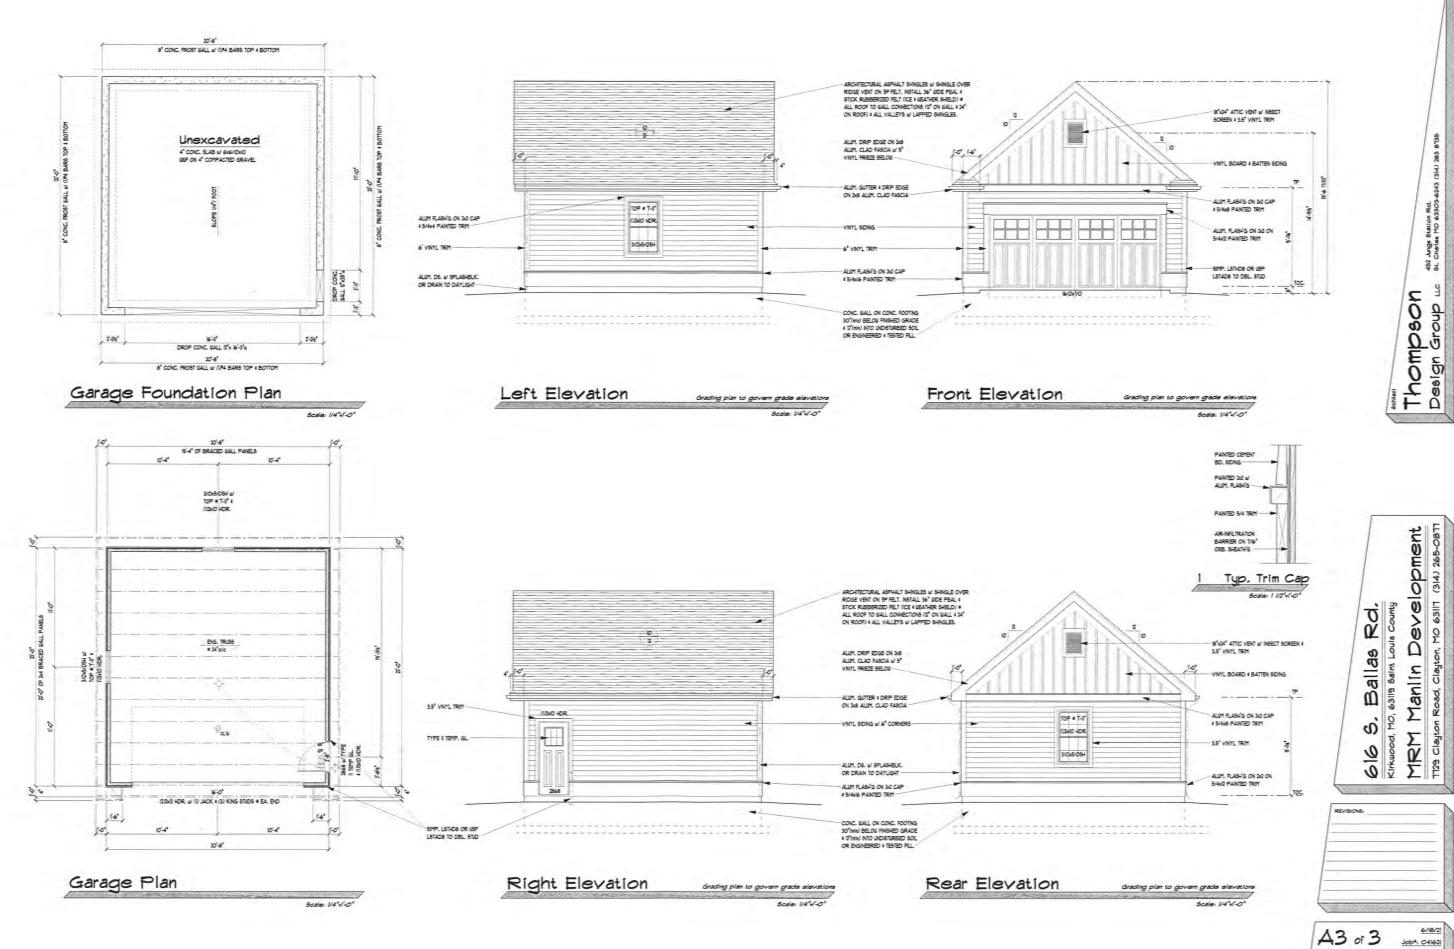

Subject Property (616 Ballas Rd)



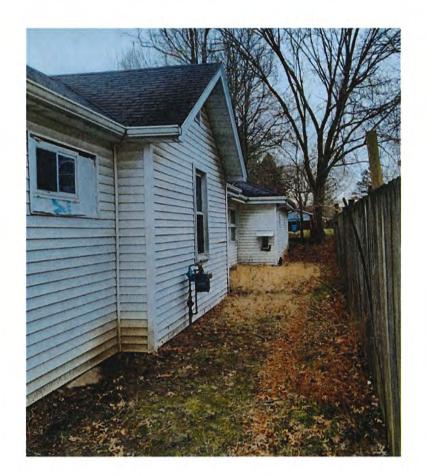







532 S. Ballas (Photo 1)



602 S. Ballas (Photo 2)





624 S. Ballas (Photo 4)



704 S. Ballas (Photo 5)




708 S. Ballas (Photo 6)




519 S. Ballas (Photo 7)



529 S. Ballas (Photo 8)

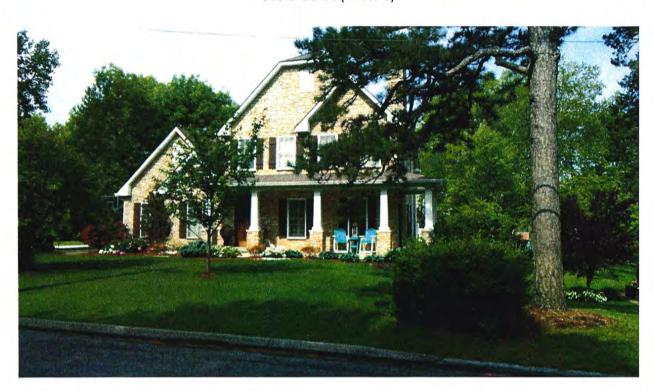

1708 Janet PI - Vacant (Photo 9)

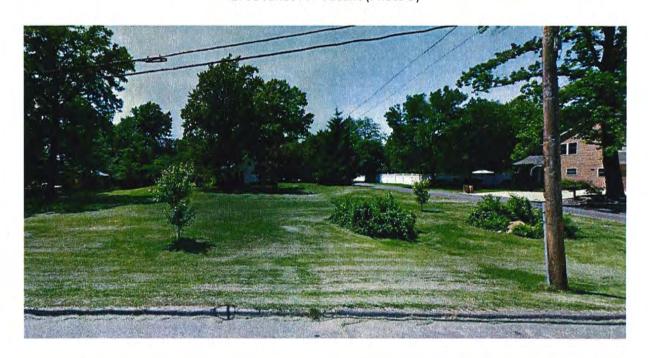


615 S. Ballas (Photo 10)



705 S. Ballas (Photo 11)



711 S. Ballas (Photo 12)

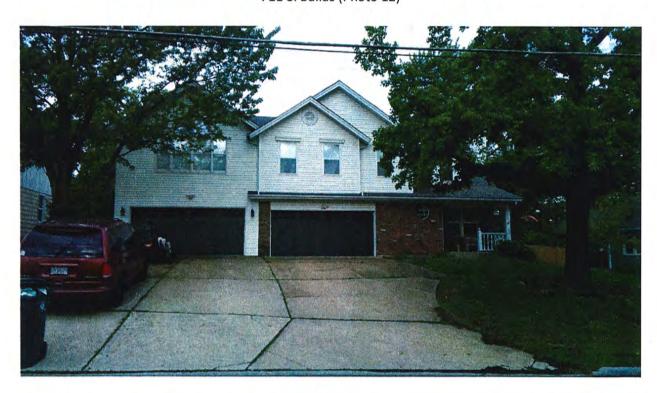

717 S. Ballas (Photo 13)





DESIGN SUBMISSION APPLICATION

Property Address 315 CRest A	ue	Zone	a R-4
s the property a Kirkwood Landmark? Ye	s No In		District? Yes No
Complete scope of work New Hov	ne Con	struction	
Construction Type/Fee: New House/\$150	Addition/\$100	Accessory Str	ucture or Other/\$100
Α	PPLICANT	- 1. As 51	AVAILABLE OF THE
Name Kingbridge Homes Address 8472 Manchester		Phone 314	1-486-9900
City, State, Zip St. Louis Mo U	03144		
E-mail (Agenda will be e-mailed to applicant)	KS @ KIN	gbridgeh	omes, com
PROF	PERTY OWNER		
Name Same As Above		Phone	
Address		10.00000	
City, State, Zip			
ARCHITE	CT INFORMAT	TON	
Name Mc Bride + Son ARChi			537-2000
Address 16091 Swingley R			
City, State, Zip Chester Field,		017	
		1111	
	In the second	1.2 July 2000	278210 12 12 12 14 15 10 10 10 10 10 10 10 10 10 10 10 10 10
agree to fully comply with the ordinance Review, Zoning, Stormwater and Building re	egulations. I he	ereby certify that t	he project is located
on property for which I have the legal right	to construct,	that the owner(s)	of record authorizes
the proposed work, and that I have been au their agent. Applicants or their representat	tive shall atten	e owner(s) to mak d all meetings.	e this application as
Tanol II		, 10 may 10 mag	6/18/21
Applicant's Signature			Date
City Use Only	100	Date Stamp	
<u> </u>			
Received by N	14 4	JUN 1 8 2021	
Agenda Date 01/06/2021 Case #_99 - 21/R			
Permit # 22 - 1204	PLBI	CE KRKWUOD LA JEKS DEPAR MEN	
Zoning Comments			
Zonning Comments			
Building Comments		The Committee of the Co	
Building Comments			





PROJECT DESCRIPTION WORKSHEET

Sect	ion A: General Information			
Natu	re of Application (Check all that apply):			
×	New Single Family Residence			
	Accessory Structure (Please Specify):			
	Other (Please Specify):			
Description of Work: New Single Family Home				
Sect	ion B: Site Context			
1) <u>B</u>	uilding Form and Articulation			
Arch	itectural Style:			
Num	ber of Stories:Building Height: 30, 5Number of Roof Lines:			
Roof	Type: Hip Primary Roof Pitch: 8			
Seco	ondary Roof Pitch: 8/12 Tertiary Roof Pitch: 9/13			
2) Bu	uilding Materials			
	ary Exterior Wall Material: Unyl Siding			
	andary Exterior Wall Material: Stone			
	ary Wall Material			
	ary Roof Material: Architectural Shingle			
	endary Roof Material:			
3) Ex	terior Windows and Doors			
Туре	of Door: Fiberglass			
Туре	of Window: Uny Pane Arrangement: Double Hong 6/6			
4) <u>De</u>	etailing			
Four	dation Wall Covering: State			
Loca	tion of Utility Equipment: Right Side			
Scre	ening of Utility Equipment:			
Sect	ion C: Neighborhood Context (New Primary Construction Only)			
	rial Palette: Any material present on 20% or more of the front facades of existing houses within			
your	Neighborhood Context is considered a Predominant Material (there may be more than one). If a			
	e material is dominant on more than 70% of the houses within the site context that material is idered to be the Single Dominant Material.			
	e Dominant Material: Utay Siding			
	ominant Material: BRick Stone			

315 Crest Ave. - Color Rendering



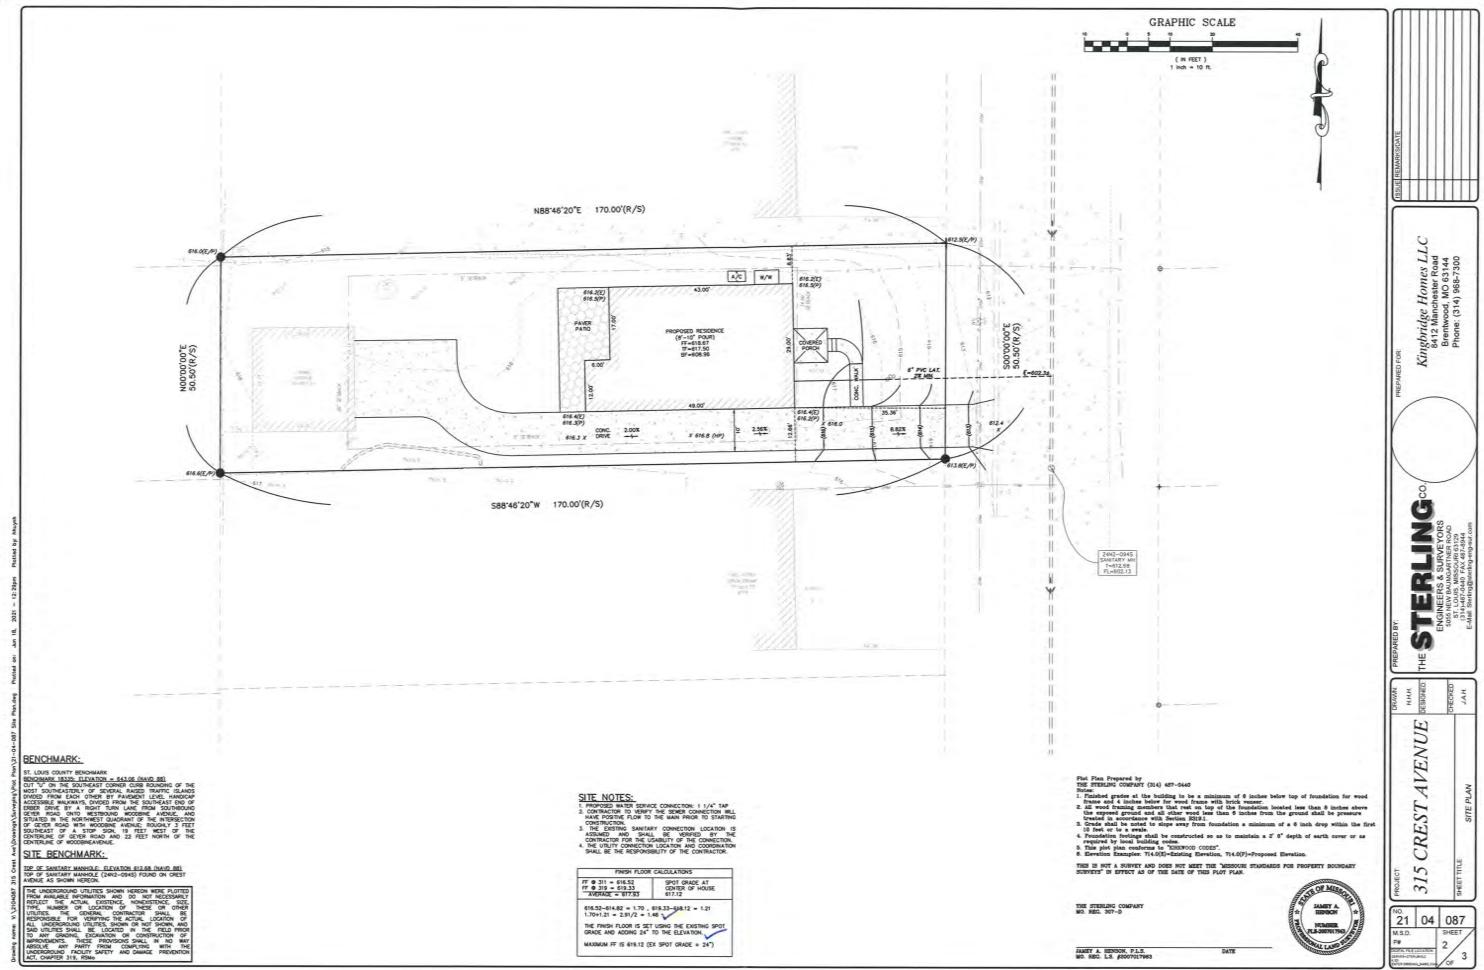

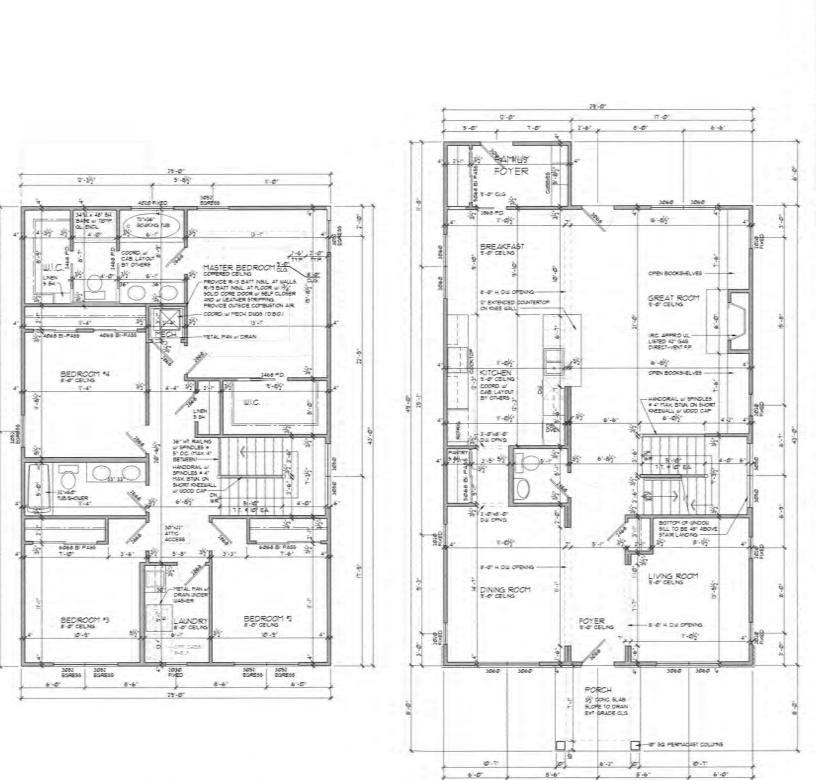

NOTE: WHERE THE OPENING OF AN OPERABLE WINDOW IS LOCATED MORE THAN 12" ABOVE THE FINISHED GRADE OR SURFACE BELOW THE LOUEST PART OF THE CLEAR OPENING OF THE WINDOW SHALL BE MINIMUM OF 24" ABOVE THE FINISHED FLOOR OF THE ROOM IN WHICH THE WINDOW IS LOCATED. GLAZING BETWEEN THE FLOOR AND 74" SHALL BE FIXED OR HAVE OPENINGS THROUGH WHICH A 4" DIAMETER SPHERE CANNOT PASS.

GENERAL NOTES

I ALL HEADERS TO BE IMMUNICIPATE, YES FOOR BY JUSTAL POST
ON 1-36 POST MACH SIZE UNLESS NOTED CREENING.

I REALTS DUST ALL HARMS ILL PARTITIONS AND AS SHOWN.

I REALTS DULLS TO SEE ALL HARMS ILL PARTITIONS AND AS SHOWN.

I REALTS DULLS TO SEE ALL HARMS INTERS STEED ARE SHOWN FOR INTENT ONLY.

THESE SYSTEMS SHALL SEE SHIPPINGS STEEDS ARE SHOWN FOR INTENT ONLY.

THESE SYSTEMS SHALL SEE SHIPPINGS STEEDS ARE SHOWN FOR INTENT ONLY.

BY THESE SHOWN AND WALL OFFENDS ARE JASANDED TO SEE CENTERED.

INCESS NOTED CHESTING.

I ALL BROOKS TO SELVINGE.

I SO INTERNATIONAL PECHANICAL CODE INC.

105 INTERNATIONAL PECHANICAL CODE INC.

106 INTERNATIONAL PECHANICAL CODE INC.

107 INTERNATIONAL PECHANICAL CODE INC.

108 INTERNATIONAL PECHANICAL CODE INC.

109 INTERNATIONAL PECHANICAL CODE INC.

109 INTERNATIONAL PECHANICAL CODE INC.

109 INTERNATIONAL PECHANICAL CODE INC.

100 INTERNATIONAL PECHANICAL SHALL PROPER AND INC. AND ONLY AND INC.

11 HINIMAN OF ONE WHOOLE HER BEDROUGH INC. IN G.-C. OR TO BRALLE OF THE SHALL PROPECTION.


12 HINIMAN OF ONE WHOOLE HER BEDROUGH AND INC. AND ASSOCIATION OF THE SHALL PROPER SHALL SH

MNIMM NET CLEAR OPENING OF 5.1 SQUARE FEET IF THE SILL IS HORE. THAN 31-8" (14") ABOVE FINISHED GRADE.

NMUM NET CLEAR OFFINING OF 5 SQUARE FEET FOR GRADE FLOOR OFFININGS

NIMM NET CLEAR OFFING HEIGHT OF 14 INCHES

TUH NET CLEAR OPENING WOTH OF 38 NO-ES

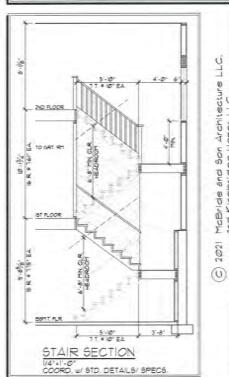

MCBRIDE & SON ARCHITECTURE

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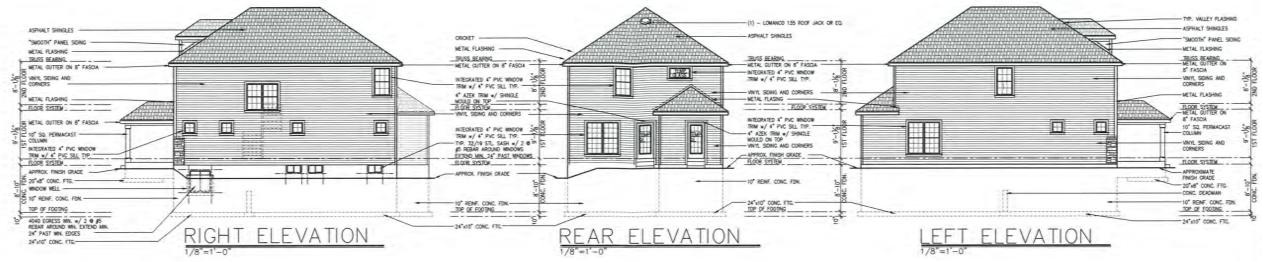
× IIIII DATE


REVISION JOB NUMBER 315 Crest


SHEET NUMBER 2

1,170° SQ. FT. COORD. W/ ROOF FRAMING ON SHT. 14

COORD, w/ 2ND FLOOR FRAMING ON SHT. 14 [3/9 50. FT.



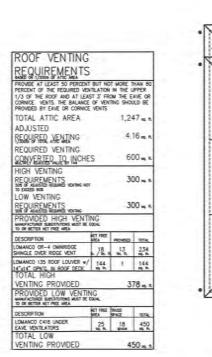

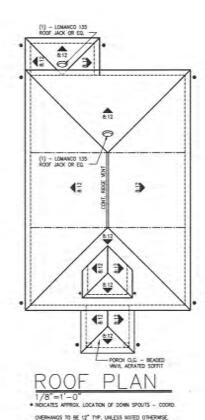



Wideride & Son Architecture, LL G di rights meaned by Midros & So Architecture, LLC (MSA) Wessel State Cartifolis of Aphlicathy A201403038 By on suffering upont of MIA. Be qualified to seed offered in the dead infection from the prediscount emblact whose name opposes to the seed offere whose production of the complete of the dead, they offere deadling of the dead, they offere deadling of one not proposed by or the responsibility was not proposed by or the responsibility of the professional emblact about the contract of the contract and are expressly decident. orry L. Gioniz, AlA, Ard MOJ A-5743 LC. 22 CUSTOM HOME: 315 CREST AVE. KIRKWOOD, MO. 6312 2021 0 KINGBRIDGE
HOMES LIC
RITALIS ANCHESTIERE
FUCUS AND SALE
PRECEDIATION OF THE PRECEDIATI * IIIII DATE REVISION JOB NUMBER 315 Crest SHEET NUMBER 5

MCBRIDE & SON ARCHITECTURE.



315 Crest Ave. Exterior Color Selections

Siding Royal Harvard Slate

Stone Pennsylvania Ledgestone/Natural Mortar

Soffit and Fascia White

Roofing Weathered Wood architectural shingles

Gutters White

Front Door Stained fiberglass door (Chestnut Mahogany)



315 Crest Ave. - "Neighborhood Context"





NORTH



315 Crest Ave.







316 Crest Ave.









304 Crest Ave

315 Crest Ave. - Existing Property Photographs



Front Rear



Left Right

315 Crest Ave. - St. Louis County Map

St. Louis County Map





Architectural Review Board Application Additions & Detached Structures

DESIGN SUBMISSION APPLICATION

	8 Cleveland Ave Zoned R-4V
s the property a Kirkwood Lar	
complete scope of work/	12 Story Lear Addition w/ tock under 9
	House/\$150 Addition/\$100 Accessory Structure or Other/\$1
Name Gakeside Rei	novation & Design Phone 636-978-5000
Address 139 Chest	
	field, mo 63005
	o applicant) danke @ bakesiderd. com
	PROPERTY OWNER
Name Carry & Wend	
Address 918 Chevelor	
City, State, Zip KINCwood	1, MO 63122
	ARCHITECT INFORMATION
Name	Phone
Address	
, , , , , , , , , , , , , , , , , , , ,	
City, State, Zip	
City, State, Zip agree to fully comply with the Review, Zoning, Stormwater as an property for which I have the	the ordinances of the City of Kirkwood, including Architect and Building regulations. I hereby certify that the project is loca the legal right to construct, that the owner(s) of record authori thave been authorized by the owner(s) to make this application
City, State, Zip	nd Building regulations. I hereby certify that the project is loca
agree to fully comply with the Review, Zoning, Stormwater and property for which I have the proposed work, and that I heir agent. Applicants or their	nd Building regulations. I hereby certify that the project is loca he legal right to construct, that the owner(s) of record authori have been authorized by the owner(s) to make this application
City, State, Zip	nd Building regulations. I hereby certify that the project is loca he legal right to construct, that the owner(s) of record authori have been authorized by the owner(s) to make this application
agree to fully comply with the Review, Zoning, Stormwater and property for which I have the proposed work, and that I heir agent. Applicants or their	nd Building regulations. I hereby certify that the project is local he legal right to construct, that the owner(s) of record authorithave been authorized by the owner(s) to make this application in representative shall attend all meetings.
agree to fully comply with the Review, Zoning, Stormwater and property for which I have the proposed work, and that I heir agent. Applicants or their agent. City Use Only	nd Building regulations. I hereby certify that the project is local he legal right to construct, that the owner(s) of record authorishave been authorized by the owner(s) to make this application in representative shall attend all meetings.
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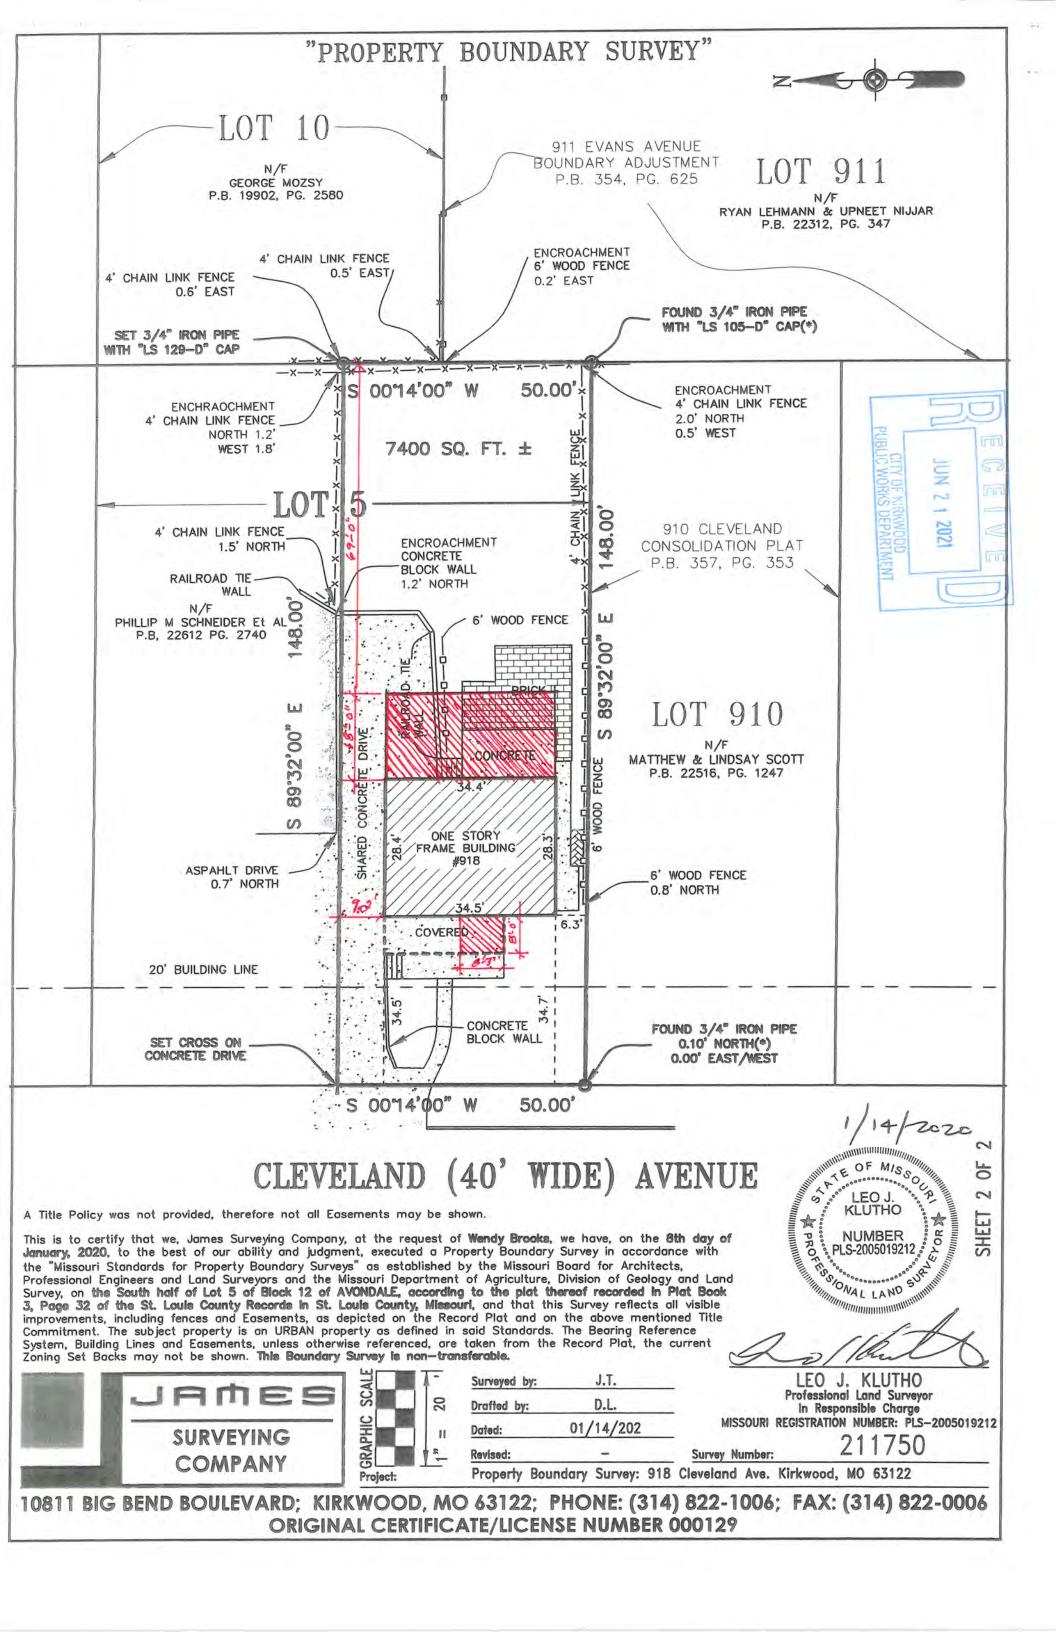
Architectural Review Board Application Additions & Detached Structures


PROJECT DESCRIPTION WORKSHEET

Sect	ion A: General Information			
Natu	re of Application (Check all that apply):			
DK	Addition or Alteration			
	Accessory Structure (Please Specify):			
	Other (Please Specify):			
Description of Work: 1/2 Story rear addition w/ tuck under garage				
Sect	ion B: Site Context			
1) <u>Bu</u>	uilding Form and Articulation			
Arch	itectural Style: Traditional			
Num	ber of Stories: 1/2 Building Height: 22/9 Number of Roof Lines: 3			
Roof	Type: Nephart Shingles Primary Roof Pitch: 12/6			
Seco	endary Roof Pitch: 12/8/2 Tertiary Roof Pitch: 12/2 - Fron 4 Porch Exist.			
	uilding Materials			
Prim	ary Exterior Wall Material: Ving / Siding - New Ahroughout			
Seco	ndary Exterior Wall Material:			
	ary Wall Material			
Prim	ary Roof Material: As phalt Shingles			
	endary Roof Material:			
	terior Windows and Doors			
Туре	of Door: Fiberglass - 3 panel			
Туре	of Window: Provia - Veny Pane Arrangement: 1/1			
	etailing			
Four	dation Wall Covering: Viny / Siding @ New foundation			
	tion of Utility Equipment: Rear of Home			
	ening of Utility Equipment:Fence			

Section C: Site Context Photos


Please attach to this application digital color photographs of all elevations of existing structures on the Subject Parcel. Photos must be a minimum 3"x4" size and may be on multiple pages:



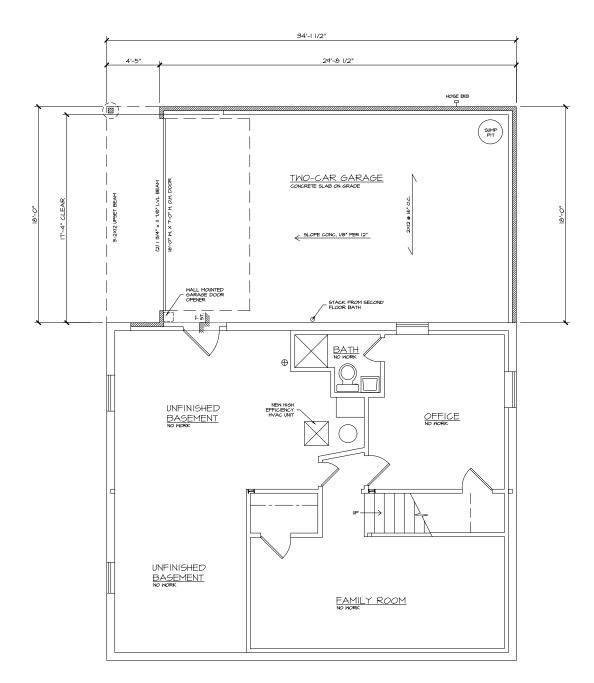

A PROPOSED BASEMENT/FOUNDATION PLAN
A2) SCALE: 1/4" = 1'-0"



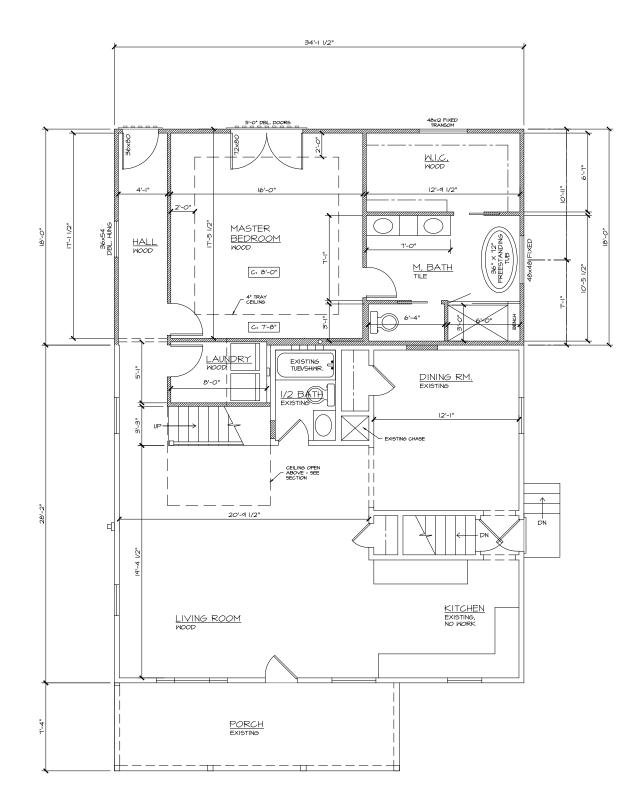





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Lakeside renovation & design CERTIFICATE OF AUTHORITY # A-2020028434

CHARLES D. NIGH REGISTERED ARCHITECT MISSOURI LICENSE #A-6065 139 CHESTERFIELD INDUSTRIAL BLVD. CHESTERFIELD, MISSOURI 63005 PHONE: 636.978.5000



LAKESIDE

139 CHESTERFIELD INDUSTRIAL BLVD. CHESTERFIELD, MISSOURI 63005 PHONE: 636.978.5000

ADDITION AND REMODEL FOR LARRY AND WENDY BROOKS 918 CLEVELAND AVE. KIRKWOOD, MO 63122

PERMIT SET: 06.01.21


REVISIONS NO. DESCRIPTION

PROPOSED BASEMENT AND FIRST FLOOR PLAN

DRAWN BY: DAN KARY SHEET #


CHECKED BY: VISHAL DOSANJH

A3

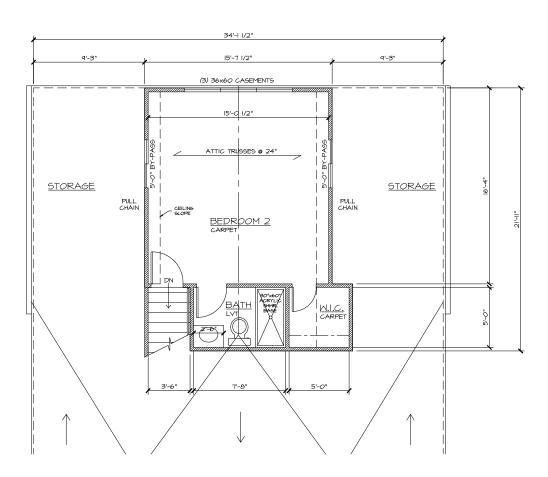

A PROPOSED SECOND FLOOR PLAN
SCALE: 1/4" = 1'-0"



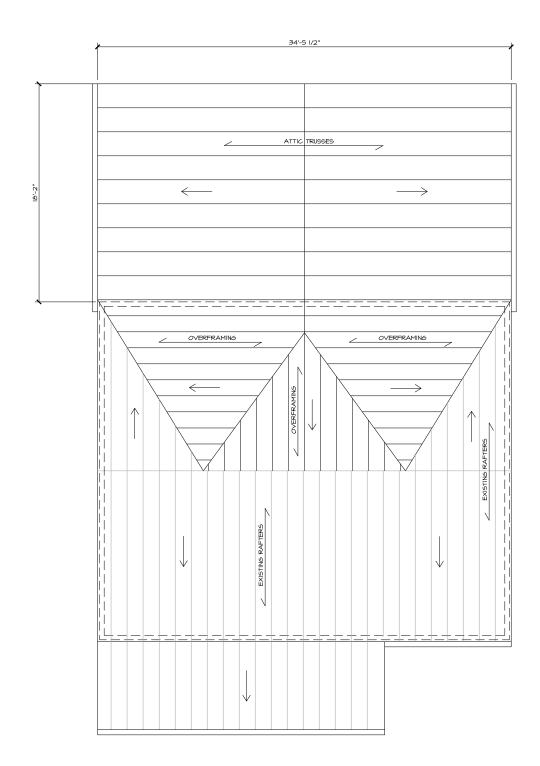

B PROPOSED ROOF PLAN
A4 SCALE: 1/4" = 1'-0"



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renovation & design 139 CHESTERFIELD INDUSTRIAL BLVD. CHESTERFIELD, MISSOURI 63005 PHONE: 636.978.5000

ADDITION AND REMODEL FOR LARRY AND WENDY BROOKS 918 CLEVELAND AVE. KIRKWOOD, MO 63122

PERMIT SET: 06.01.21

REVISIONS
NO. DESCRIPTION DATE

PROPOSED SECOND FLOOR AND ROOF PLAN

DRAWN BY: DAN KARY SHEET #

CHECKED BY:


VISHAL DOSANJH

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EXISTING FRONT ELEVATION

SCALE: 1/4" = 1'-0" A A6



C EXISTING REAR ELEVATION A6 | SCALE: 1/4" = 1'-0"

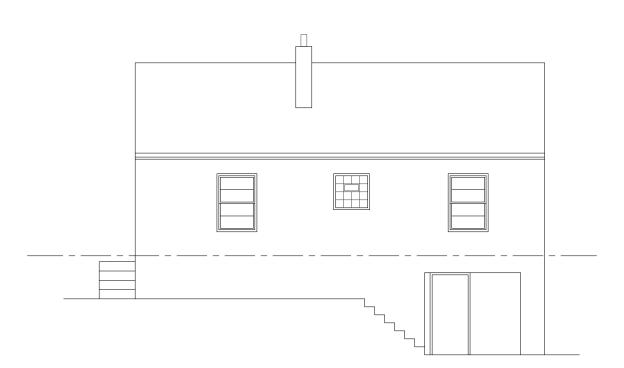

B PROPOSE! A6 SCALE: 1/4" = 1'-0" PROPOSED FRONT ELEVATION



D PROPOSED REAR ELEVATION
A6 SCALE: 1/4" = 1'-0"

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LAKESIDE renovation & design 139 CHESTERFIELD INDUSTRIAL BLVD. CHESTERFIELD, MISSOURI 63005 PHONE: 636.978.5000

ADDITION AND REMODEL FOR LARRY AND WENDY BROOKS 918 CLEVELAND AVE. KIRKWOOD, MO 63122

PERMIT SET:
06.01.21
REVISIONS
NO. DESCRIPTION DATE

PROPOSED EXTERIOR ELEVATIONS

DRAWN BY: DAN KARY SHEET #

CHECKED BY: VISHAL DOSANJH

A6



EXISTING LEFT SIDE ELEVATION SCALE: 1/4" = 1'-0"



C EXISTING RIGHT SIDE ELEVATION A4) SCALE: 1/4" = 1'-0"



B A7 PROPOSED LEFT SIDE ELEVATION SCALE: 1/4" = 1'-0"



D A4 PROPOSED RIGHT SIDE ELEVATION

SCALE: 1/4" = 1'-0" AS AN INSTRUMENT OF SERVICE, THIS DOCUMENT IS AND REMAINS THE PROPERTY OF LAKESIDE RENOVATION & DESIGN, AND MAY NOT BE USED FOR ANY PROJECT OTHER THAN THAT FOR WHICH IT WAS ORGINALLY INTENDED. LAKESIDE PROVATION & DESIGN LAKESIDE PROVATION & DESIGN LAKESIDE PROMIT OF THE ADVERSE CONSEQUENCES OF DEVALOTIONS FROM INFORMATION PROVIDED IN THIS DOCUMENT, UNLESS SPECIFICALLY APPROVED IN WRITING BY LAKESIDE RENOVATION & DESIGN. CONTRACTOR IS RESPONSIBLE FOR QUANTITIES, CONDITIONS, FIELD DIMENSIONS, JOB COORDINATION, PROJECT METHODS AND ALL OTHER CONTRACT REQUIREMENTS.

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PHONE: 636.978.5000



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ADDITION AND REMODEL FOR LARRY AND WENDY BROOKS 918 CLEVELAND AVE. KIRKWOOD, MO 63122

PERMIT SET: 06.01.21 REVISIONS NO. DESCRIPTION D

PROPOSED EXTERIOR ELEVATIONS

SHEET #

CHECKED BY: VISHAL DOSANJH

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920 CLEVELAND

明明.




908 CLEVELAND



910 CLEVELAND




922 CLEVELAND

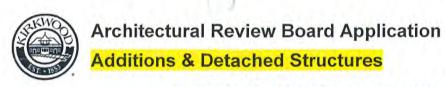

DESIGN SUBMISSION APPLICATION

Property Address 438 Greenleaf Dr.	Zoned R-3 V
s the property a Kirkwood Landmark? Yes No	
complete scope of work Screened in porch over	existing deak and family room e
Construction Type/Fee: New House/\$150 Addition/	/\$100 Accessory Structure or Other/\$1
APPLICANT	the second secon
Name Jared Byers	Phone 314-575-3116
Address 1905 N. Signal Hills Or.	
City, State, Zip Kirkwood, MD 63122	
E-mail (Agenda will be e-mailed to applicant) Joved L	Byers@hotmail.com
PROPERTY OW	
Name Janet Bolinske	Phone 314-504-3706
Address 438 Greenleaf Dr.	
City, State, Zip Kirkwood, MO 63122	
ARCHITECT INFOR	Phone
Address	
Address	
City State Zin	
City, State, Zip	
agree to fully comply with the ordinances of the	
	. I hereby certify that the project is loca
agree to fully comply with the ordinances of the leview, Zoning, Stormwater and Building regulations n property for which I have the legal right to constru he proposed work, and that I have been authorized b	i. I hereby certify that the project is loca uct, that the owner(s) of record authori by the owner(s) to make this application
agree to fully comply with the ordinances of the Review, Zoning, Stormwater and Building regulations In property for which I have the legal right to constru The proposed work, and that I have been authorized be Their agent. Applicants or their representative shall a	i. I hereby certify that the project is local uct, that the owner(s) of record authori by the owner(s) to make this application attend all meetings.
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agree to fully comply with the ordinances of the Review, Zoning, Stormwater and Building regulations in property for which I have the legal right to construct proposed work, and that I have been authorized being agent. Applicants or their representative shall a policant's Signature City Use Only	Let I hereby certify that the project is local uct, that the owner(s) of record authority the owner(s) to make this application attend all meetings. G-18-21 Date Date Stamp Date Date
agree to fully comply with the ordinances of the Review, Zoning, Stormwater and Building regulations in property for which I have the legal right to construct proposed work, and that I have been authorized being agent. Applicants or their representative shall a policant's Signature	i. I hereby certify that the project is local uct, that the owner(s) of record authority the owner(s) to make this application attend all meetings. 6-18-21 Date
agree to fully comply with the ordinances of the Review, Zoning, Stormwater and Building regulations in property for which I have the legal right to construct the proposed work, and that I have been authorized being agent. Applicants or their representative shall a pplicant's Signature City Use Only Received by	i. I hereby certify that the project is local cuct, that the owner(s) of record authority the owner(s) to make this application attend all meetings. 6-18-21 Date Date Stamp JUN 2 1 2021
agree to fully comply with the ordinances of the Review, Zoning, Stormwater and Building regulations in property for which I have the legal right to construct the proposed work, and that I have been authorized be heir agent. Applicants or their representative shall a pplicant's Signature City Use Only Received by Agenda Date 07 06/202	Let I hereby certify that the project is local uct, that the owner(s) of record authority the owner(s) to make this application attend all meetings. G-18-21 Date Date Stamp Date Date
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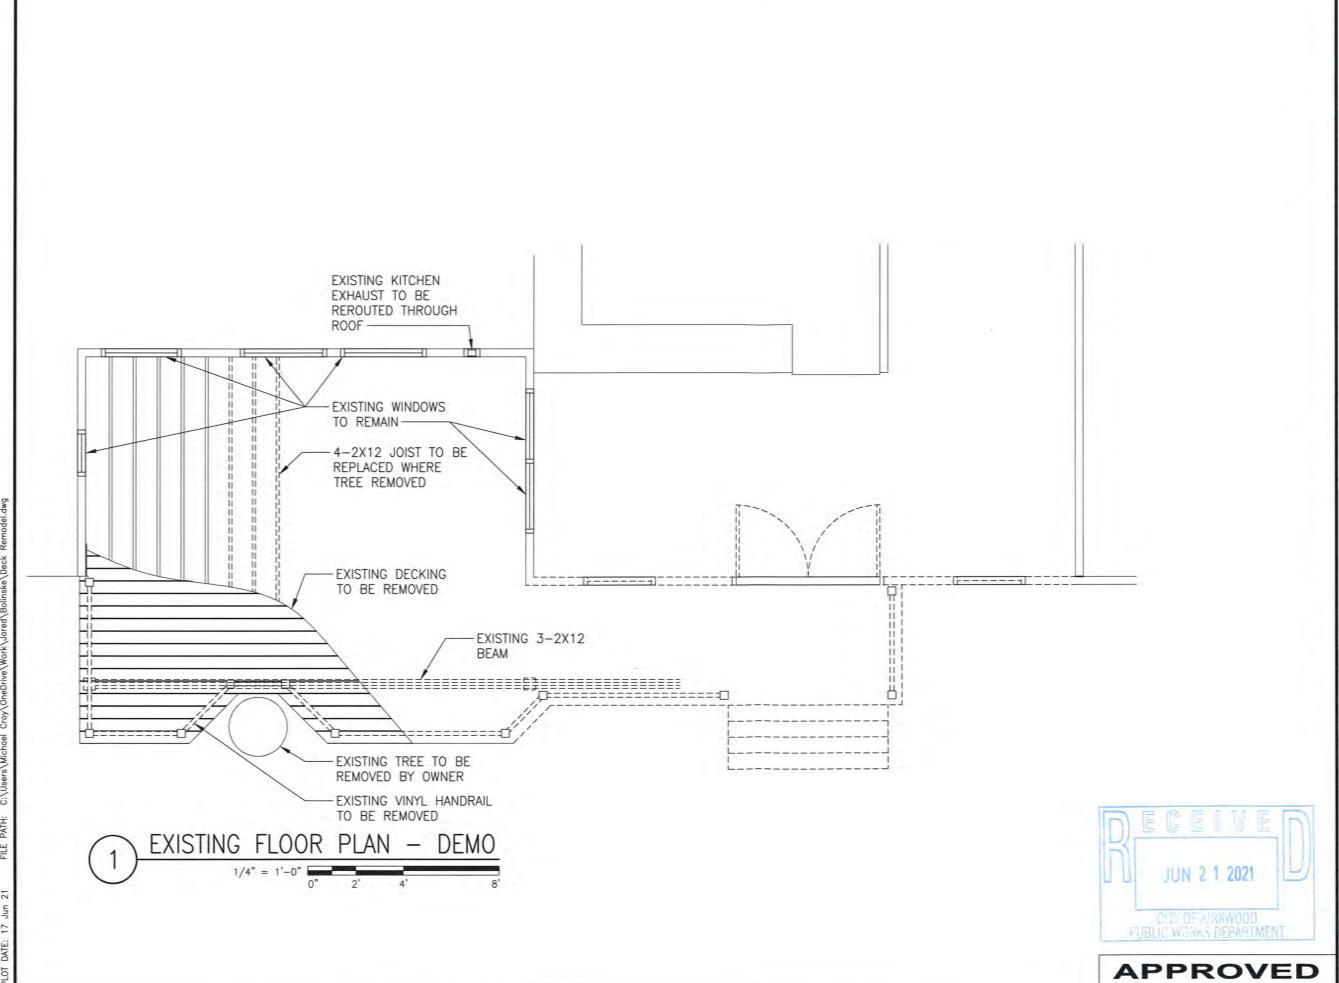
PROJECT DESCRIPTION WORKSHEET

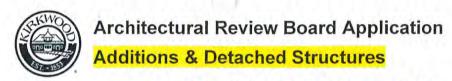-			
Sect	ion A: General Information		
Natu	re of Application (Check all that apply):		
0	Addition or Alteration		
	Accessory Structure (Please Specify):		
	Other (Please Specify):		
Description of Work: Screenedin perch over existing deck and family room extension			
Sect	ion B: Site Context		
1,4	uilding Form and Articulation		
Archi	itectural Style: Kanch		
Num	ber of Stories: 1-1/2 Building Height: 20 Number of Roof Lines: 5		
	Type: Gable Primary Roof Pitch: 6/12		
Seco	ndary Roof Pitch: 3/12 Tertiary Roof Pitch:		
2) <u>B</u> L	uilding Materials		
	ary Exterior Wall Material: Brick		
Seco	ndary Exterior Wall Material: Siding (vinyl)		
	ary Wall Material		
Prima	ary Roof Material: Asphalt		
	ndary Roof Material:		
3) Ex	terior Windows and Doors		
Туре	of Door: Front in 6 panel w/2 lites, Side door is 2 panel w/9 lite		
Туре	of Window: Viny I double hung Pane Arrangement: grills		
4) <u>De</u>	etailing		
Foun	dation Wall Covering: None		
Loca	tion of Utility Equipment: See Plans		
Scree	ening of Utility Equipment: None		


Section C: Site Context Photos

Please attach to this application digital color photographs of all elevations of existing structures on the Subject Parcel. Photos must be a minimum 3"x4" size and may be on multiple pages:

Lot 59 WOODLAWN TERRACE É À SIRIP OF LAND IN SECTION 36 (TOURShip 45 NOVEM Range 5 East 120.01 Ro 173.93 side yard Family Recon Screen Porch WIRCOF Brick + Fre (lat (Nb. 438) tard Long W. SCRIF 1"220 Secondary Front yard Drive (so'wide) Greenlest It has been agreed for Topos Surveying & Engineering Corp. to execute a survey, which is commonly known as a Mortgage Inspection Survey, Spot Survey, or Location of Improvements L Be it known that this survey does not meet the following requirements as defined in the Minimum Standards for Boundary Surveys [10 CSR 30-2.010 of the State Regulation.] 1- Out To 1. No corner monuments have been set Possession lines are not shown 8- P-T No fences are shown 3. Deeded description is followed in accordance to information provided by client Building Lines and Easements are shown in accordance with the recorded plat unless otherwise noted This is to certify that Topos Surveying & Engineering during the month of July 1992, at the request of Langer's Tirle Co made a mort inspection survey, spot survey, as described above to locate the improvements on Weedlaumn Terrace. No T Terrace Book 4 as recorded in Flat Book 45 Poge 37 of the St. Louis Countrecords, Missouri, and that the results are correctly represented upon this plat. Nicholas C. Pappas, C. PAPPAS Order No. Drn By:





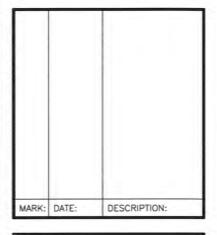

OWNER:

JANET BOLINSKE

438 GREENLEAF DR

SAINT LOUIS, MO 63122

PROJECT TITLE:


SHEET TITLE:

DECK & ROOM DEMO PLAN

PROJECT No.

SHEET No.


A-1D

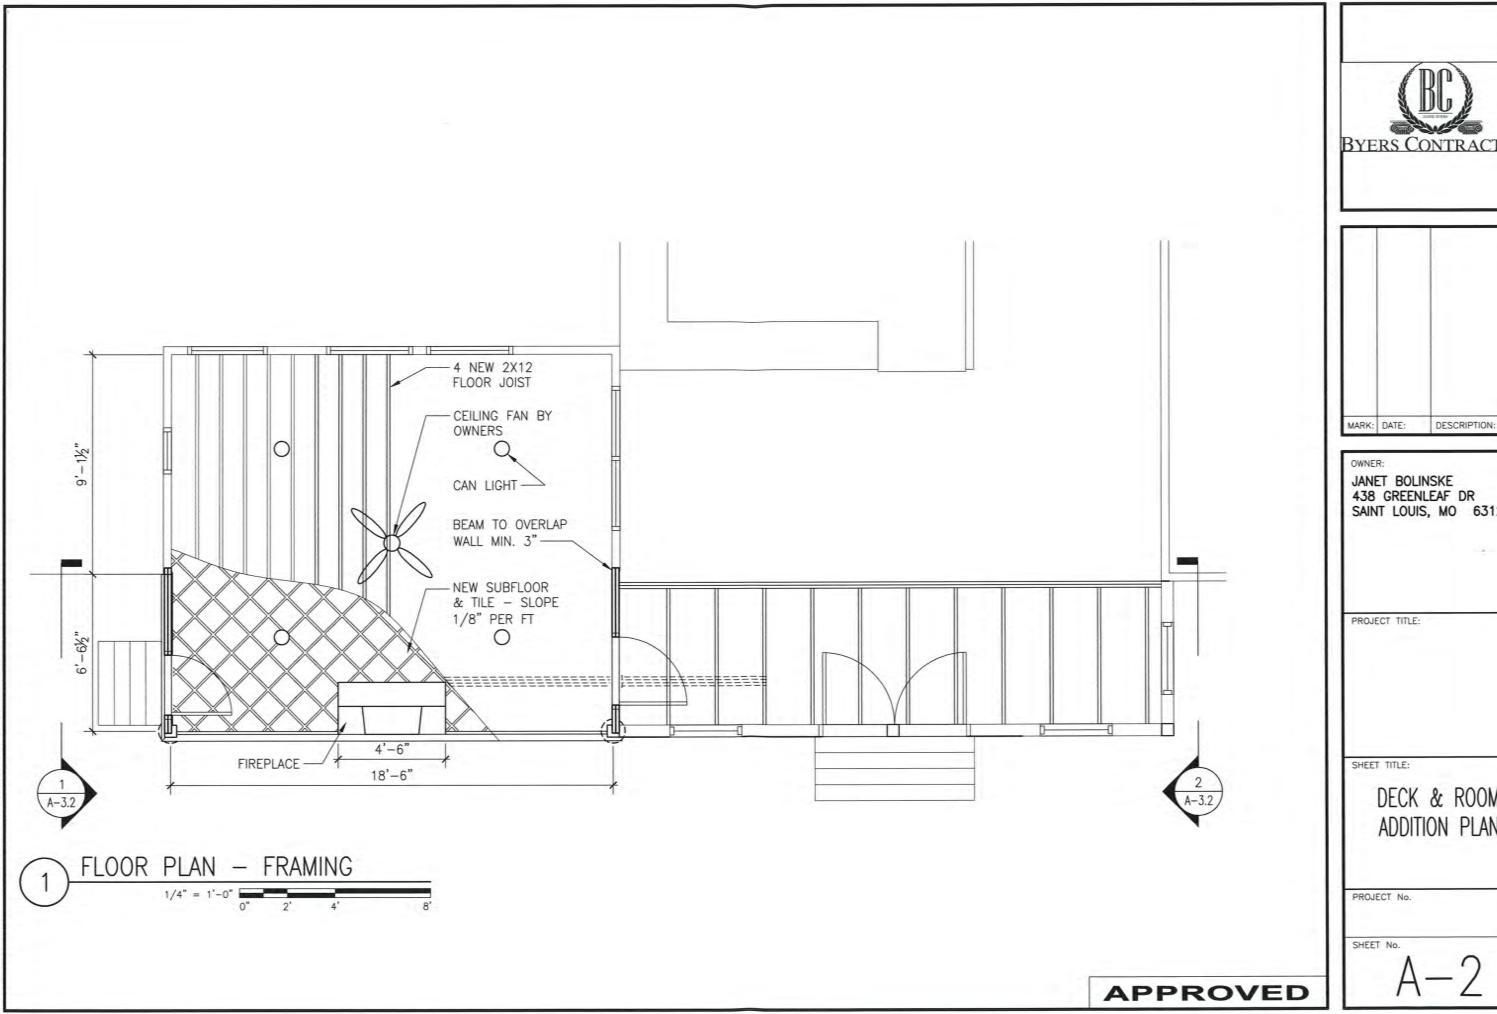


BYERS CONTRACTING

438 GREENLEAF DR SAINT LOUIS, MO 63122

DECK & ROOM ADDITION PLAN

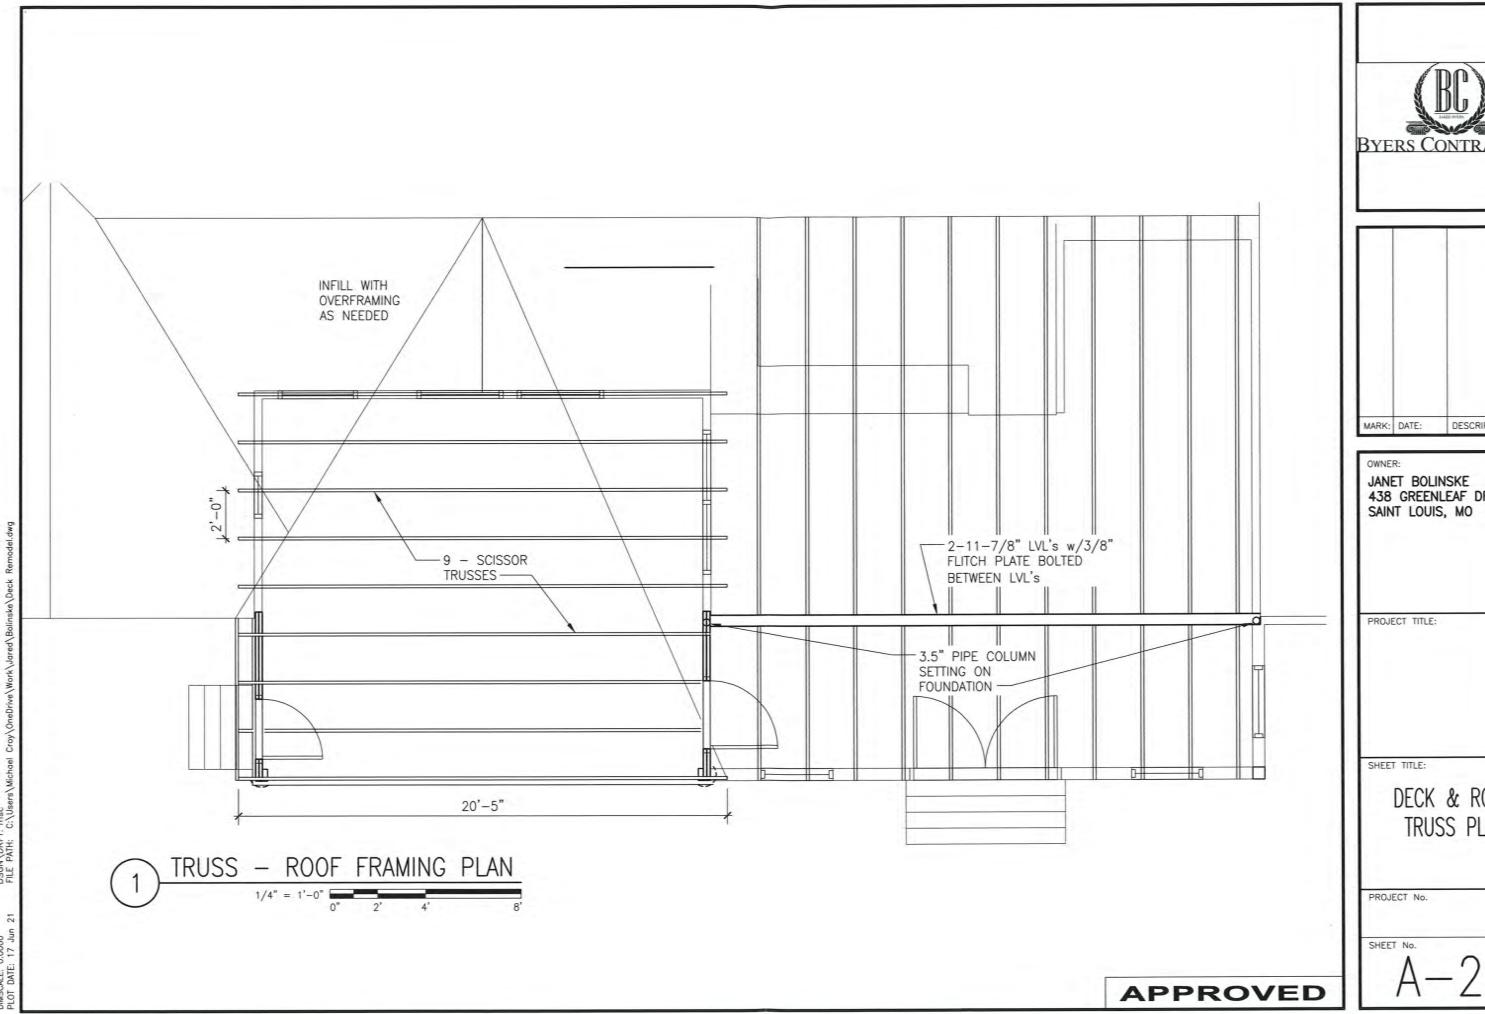



BYERS CONTRACTING

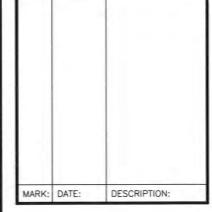


JANET BOLINSKE 438 GREENLEAF DR SAINT LOUIS, MO 63122

DECK & ROOM TRUSS PLAN

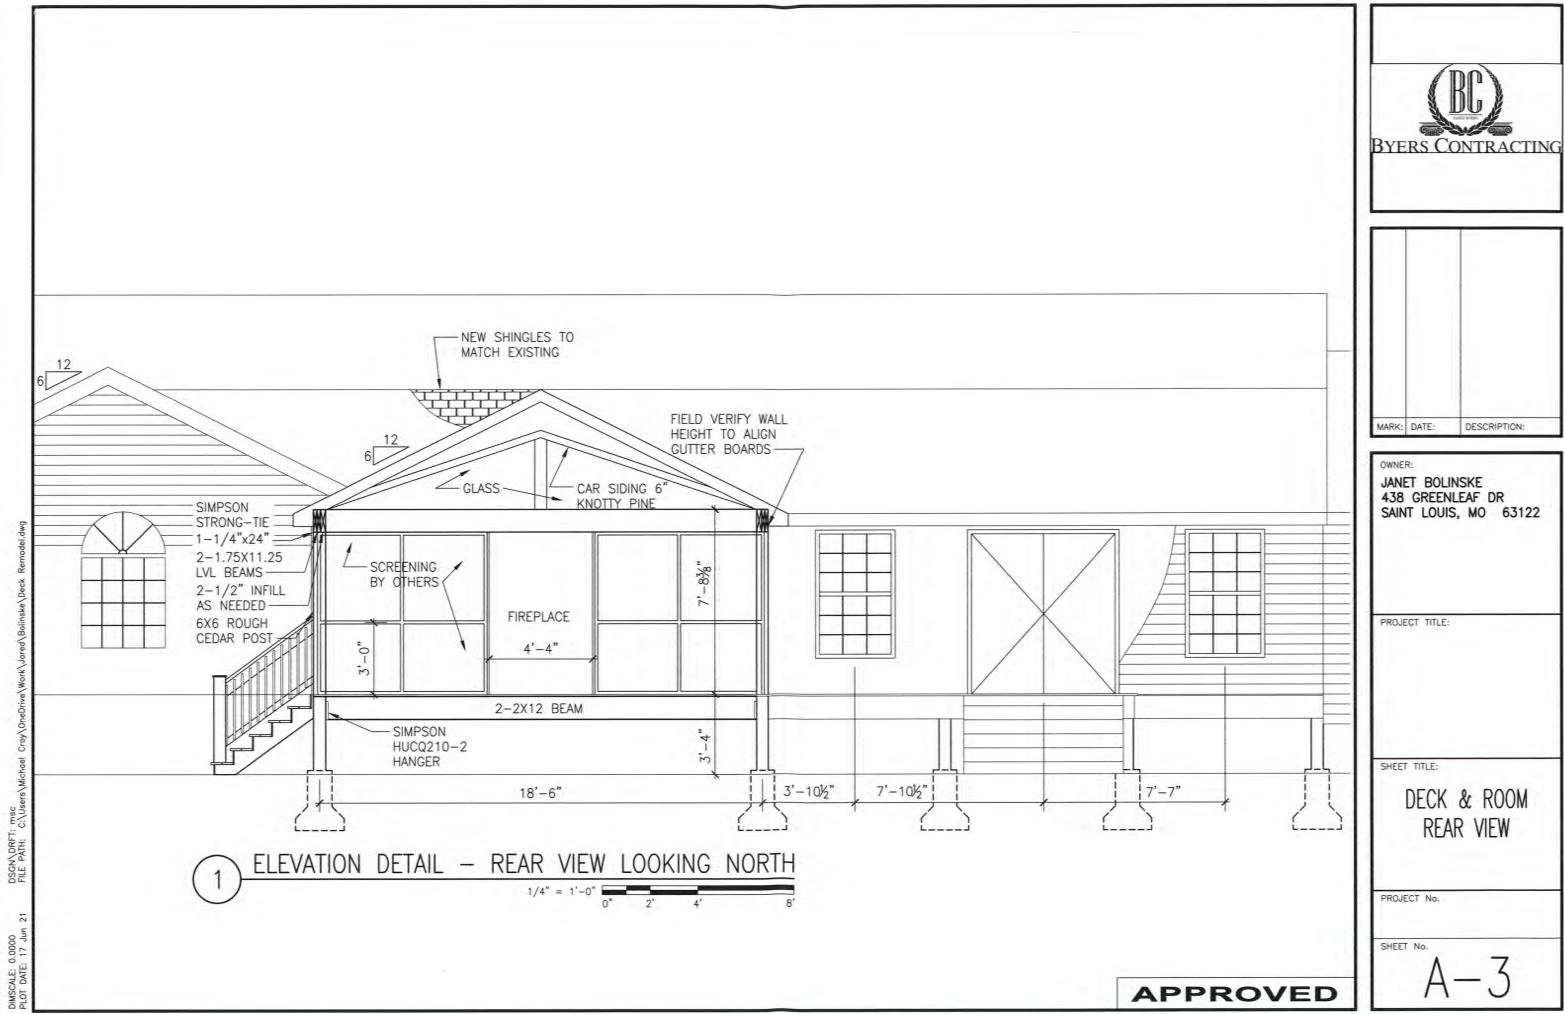

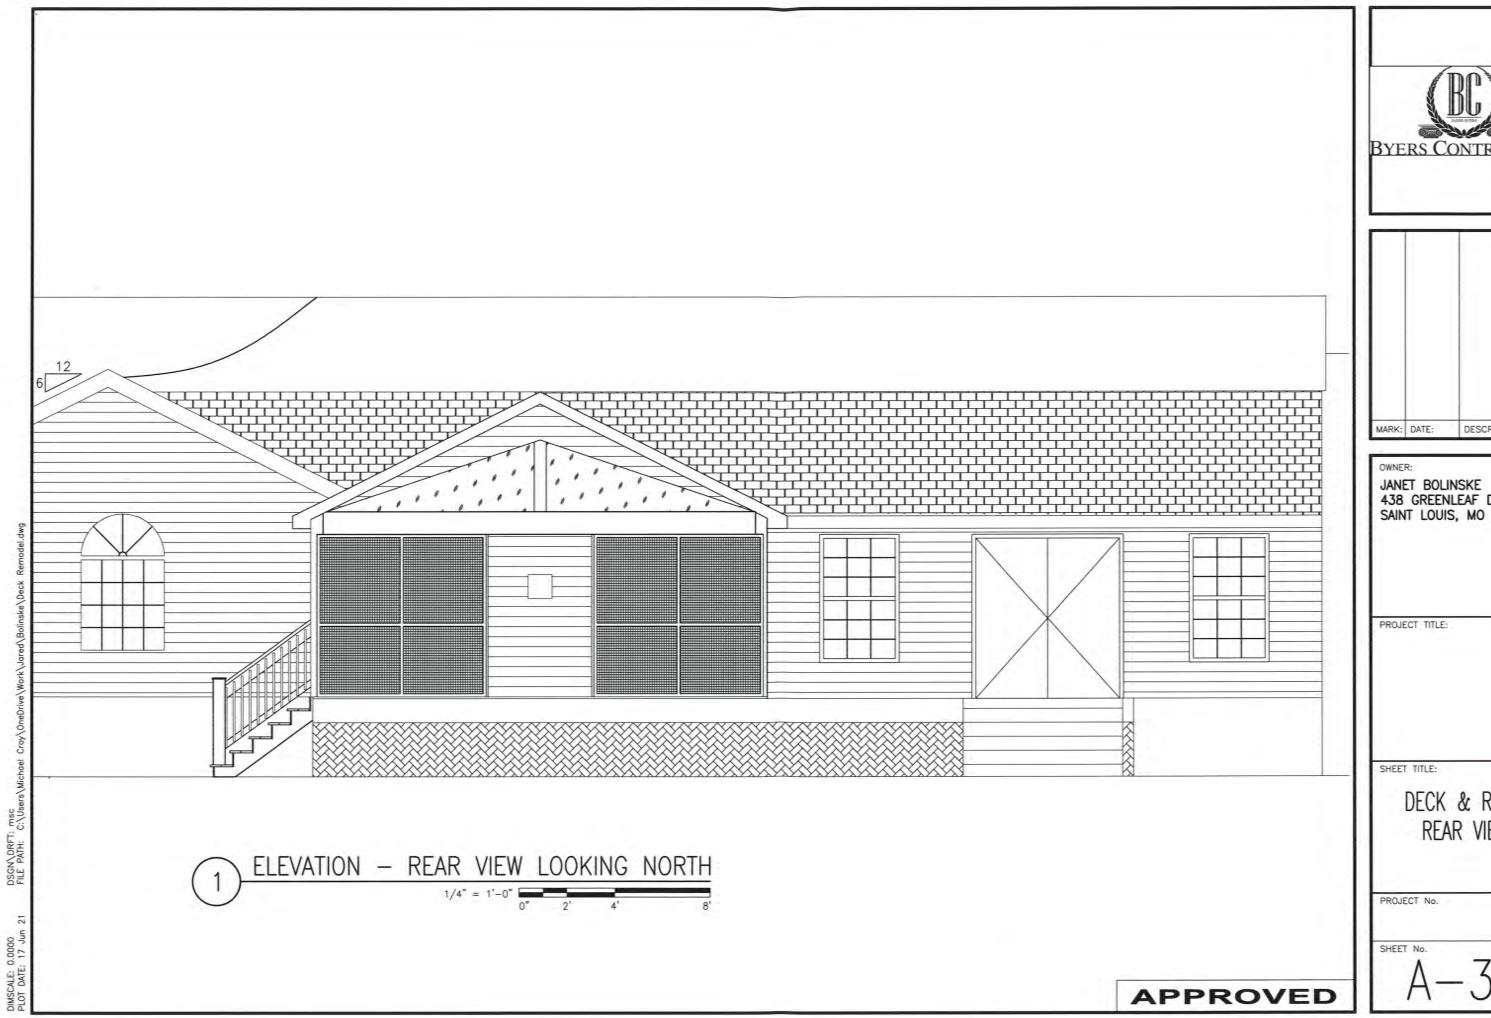




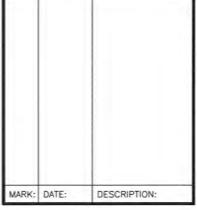


JANET BOLINSKE 438 GREENLEAF DR SAINT LOUIS, MO 63122

DECK & ROOM REAR VIEW

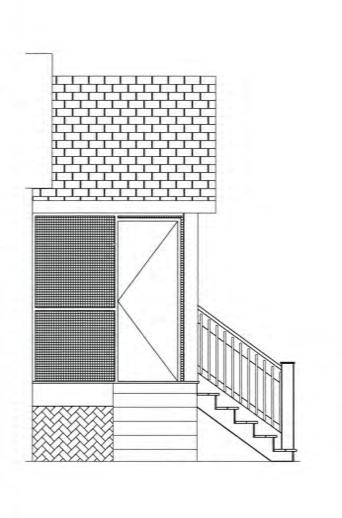




DIMSCALE: 0.0000 PLOT DATE: 17 Jun 21

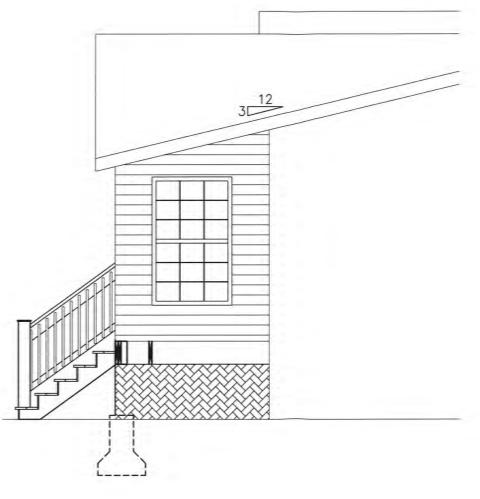




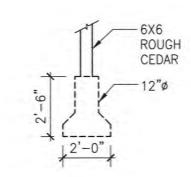



BYERS CONTRACTING

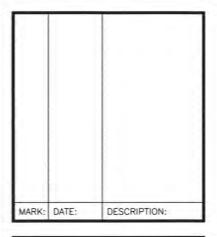

JANET BOLINSKE 438 GREENLEAF DR SAINT LOUIS, MO 63122

PROJECT TITLE:

SHEET TITLE:

DECK & ROOM ELEVATIONS

PROJECT No.

SHEET No.

A - 3.2

APPROVED







